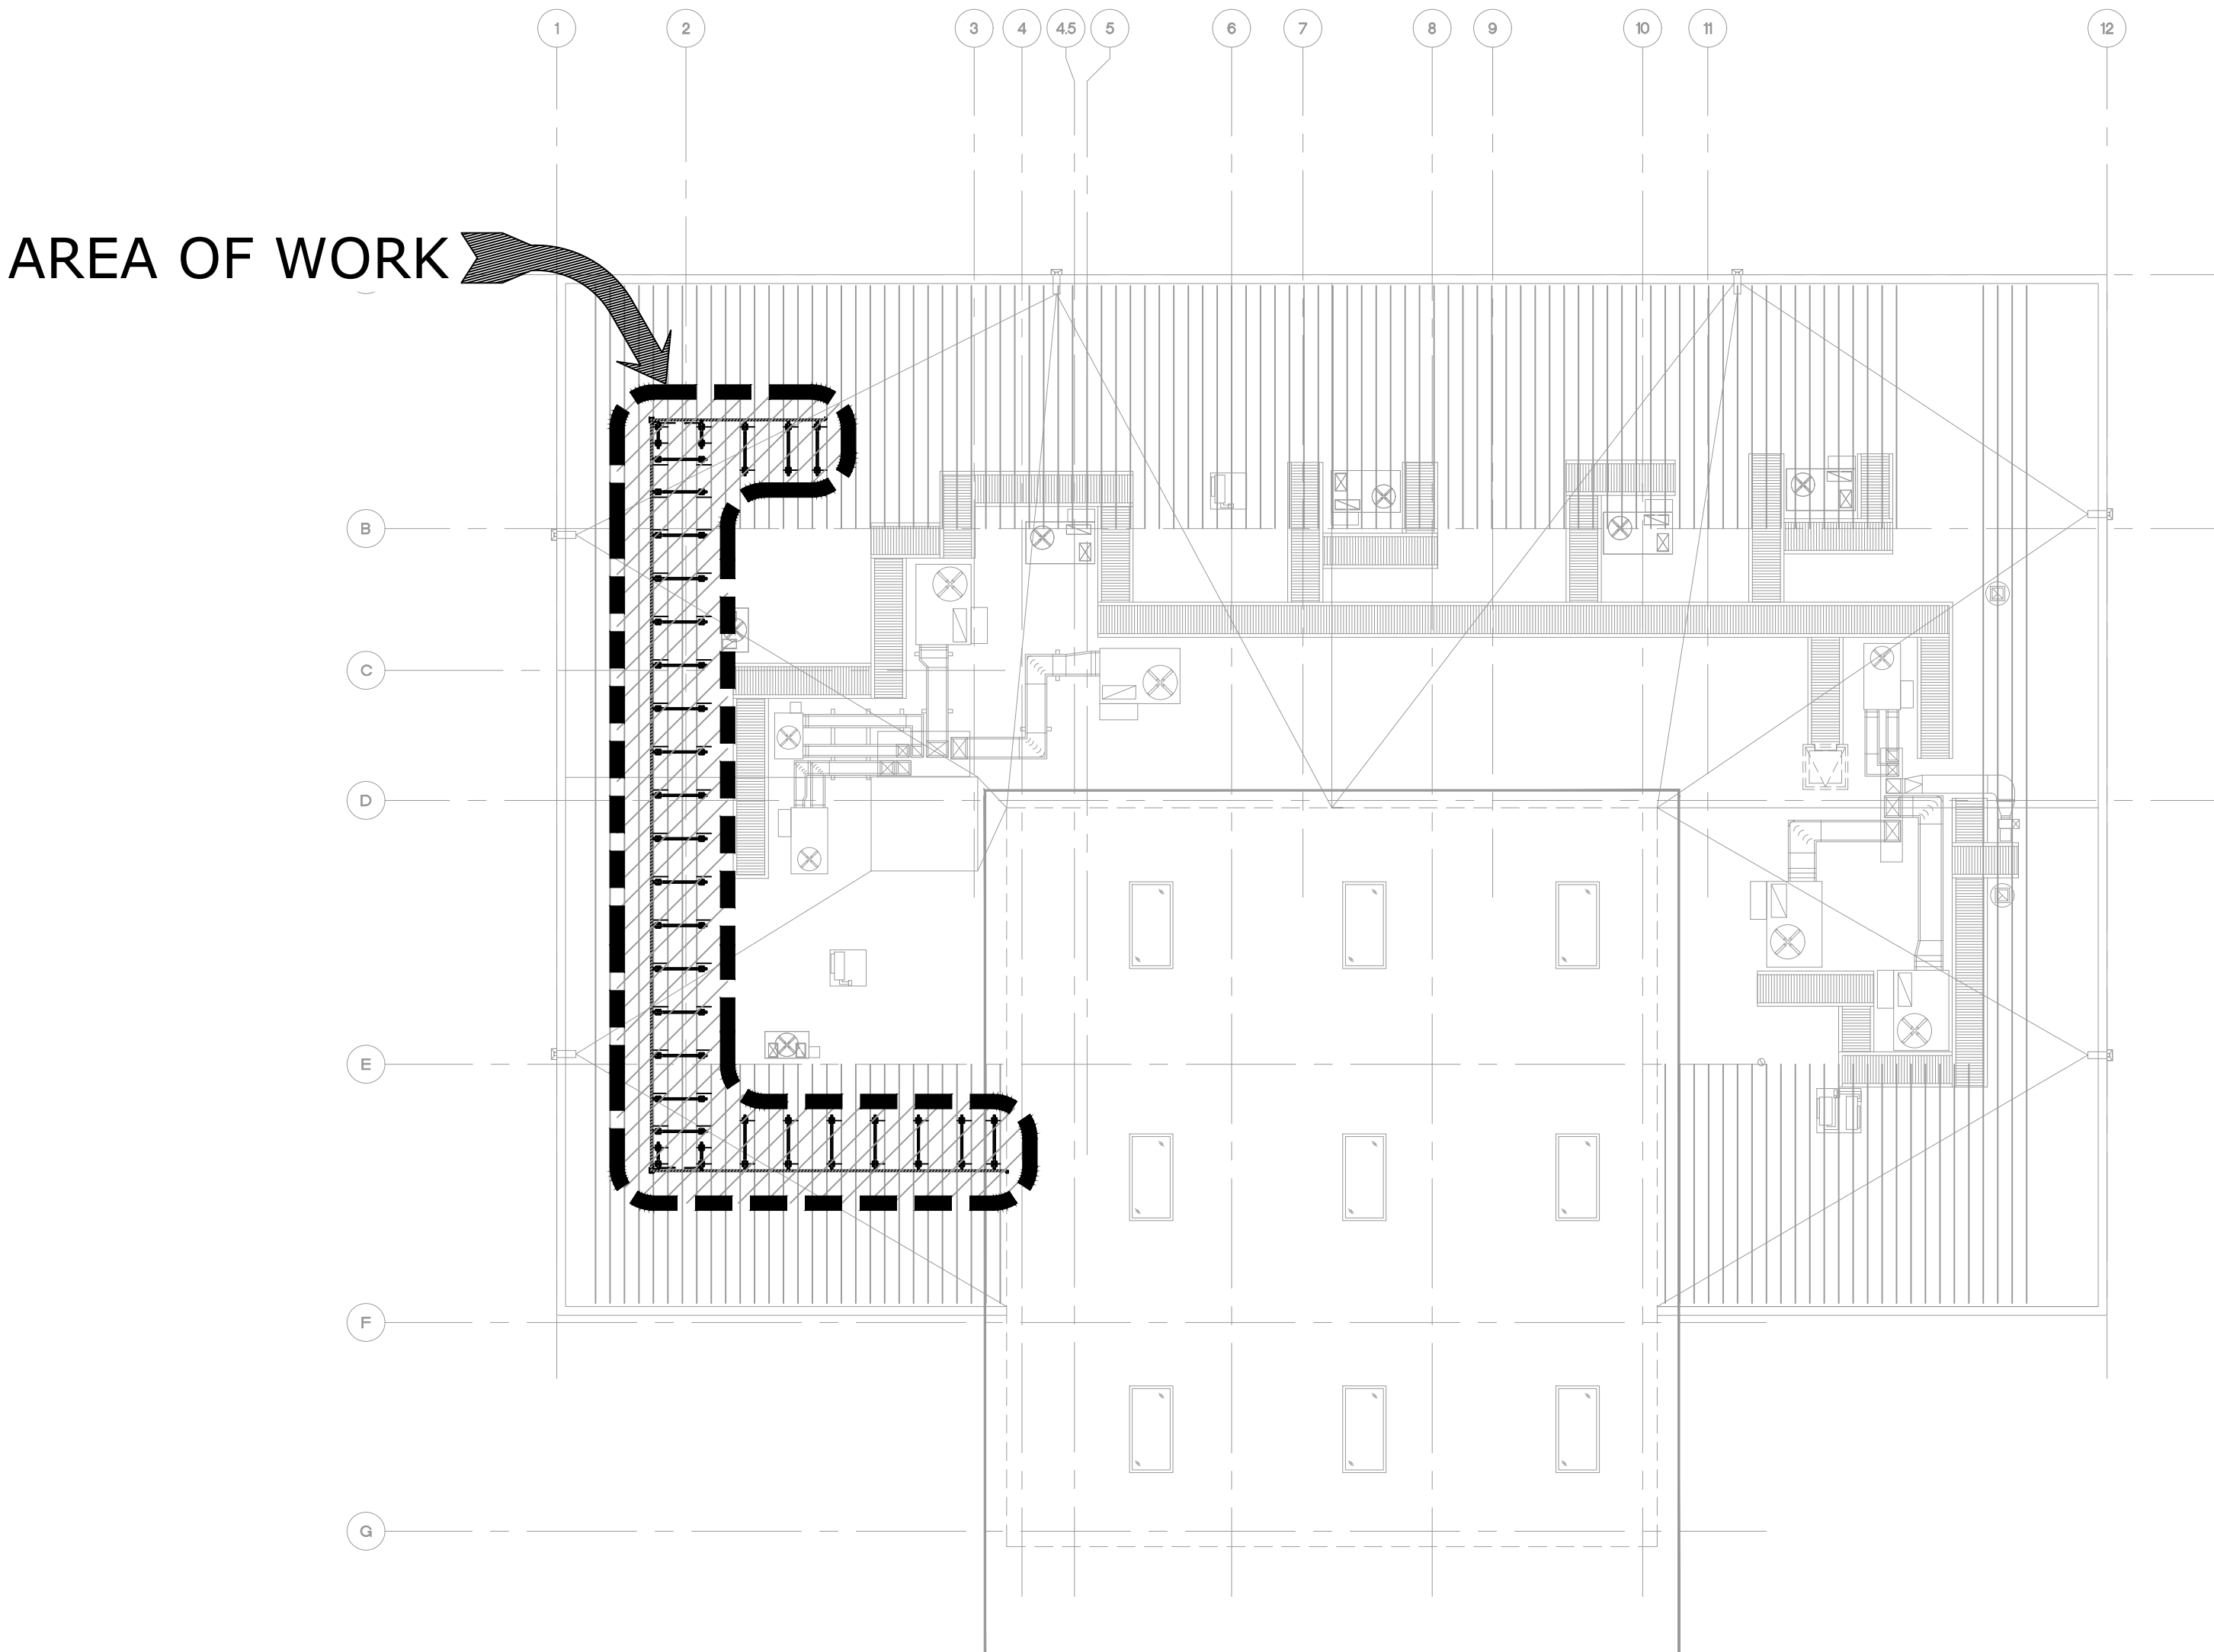


ROOFSCREEN CONSTRUCTION DOCUMENTS:

RS LT SAMPLE PLANS


CONSTRUCTION DOCUMENT DATED: 11/16/23
LOCATION: 347 CORAL ST
SANTA CRUZ, CA 95060



SHEET INDEX

SHEET	CONTENTS
RS-0	CODE ANALYSIS, SITE PLAN, SHEET INDEX, AREA MAP, VICINITY MAP, SCOPE OF WORK
RS-1	ROOFSCREEN FRAMING PLAN
RS-2	ROOFSCREEN PANEL PLAN
RS-3	ROOFSCREEN FRAME DETAILS & SPECIFICATIONS
RS-4	ROOFSCREEN PART/ASSEMBLY DETAILS

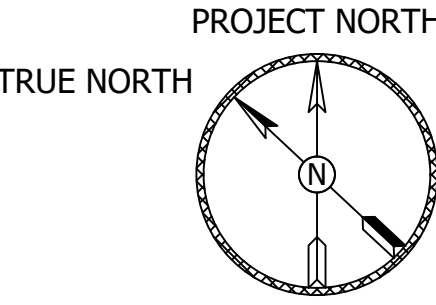SITE PLAN
SCALE: NTS



CODE ANALYSIS

ALL WORK SHALL COMPLY WITH THE 2019 CALIFORNIA BUILDING CODE (CBC)

RISK CATEGORY.....(ASCE 7, TABLE 1-1) II

WIND DESIGN CRITERIA:
WIND SPEED.....(IBC FIG 1609) 92 MPH
WIND EXPOSURE.....(IBC 1609.4.3) C
C&C WIND PRESSURE.....(ASCE 7 6.4.1.2) XX PSF

SEISMIC DESIGN CRITERIA:
BY INSPECTION SEISMIC FORCES DO NOT GOVERN OVER WIND.

MATERIAL SPECIFICATIONS

STRUCTURAL STEEL & MISCELLANEOUS IRON:

ROUND TUBING: GALVANIZED 16 GA ASTM A500 GRADE B, MIN Fy = 40 KSI
PROPRIETARY PARTS GALVANIZED 11 GA ASTM A500 GRADE C, MIN Fy = 50 KSI
POLYESTER POLYURETHANE POWDER COATED
ASTM A1008-CS TYPE A, Fy = 34 KSI
BASE SUPPORT BASE PLATE, ASTM A36, Fy = 36 KSI
STAINLESS STEEL AISI TYPE 304, Fy = 31.2 KSI
6063 T6, Ftu = 30 KSI
ASTM F593C/G (AISI 18-8)
AISI 18-8
E70XX
ITW BUILDEX W/ CLIMASEAL (ESR 1976) OR APPROVED EQUAL

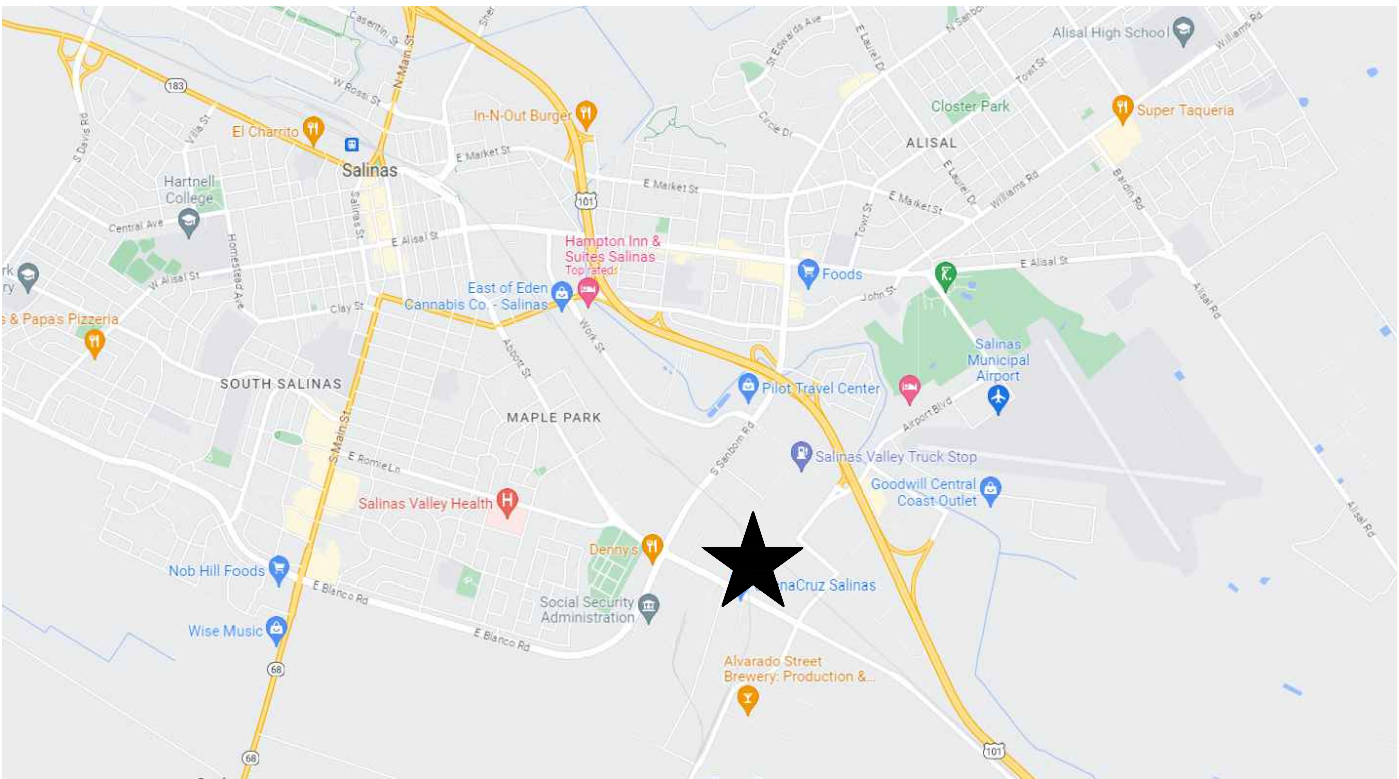
EXTRUDED ALUMINUM:
STAINLESS STEEL BOLTS
STAINLESS STEEL NUTS AND WASHERS
WELDING ELECTRODES
SELF DRILLING SELF TAPPING SCREWS

SCOPE OF WORK


NEW ROOFSCREEN

NOTE: EVALUATION OF EXISTING ROOF SHEATHING, ROOF FRAMING, AND BUILDING FOR NEW MECHANICAL EQUIPMENT AND SCREEN LOADS (INCLUDING SNOW DRIFT LOADING EFFECTS) SHALL BE PROVIDED BY OTHERS. LOAD REACTIONS AT BASE SUPPORTS ARE LISTED ON FRAME SPECIFICATIONS.

AREA MAP



VICINITY MAP

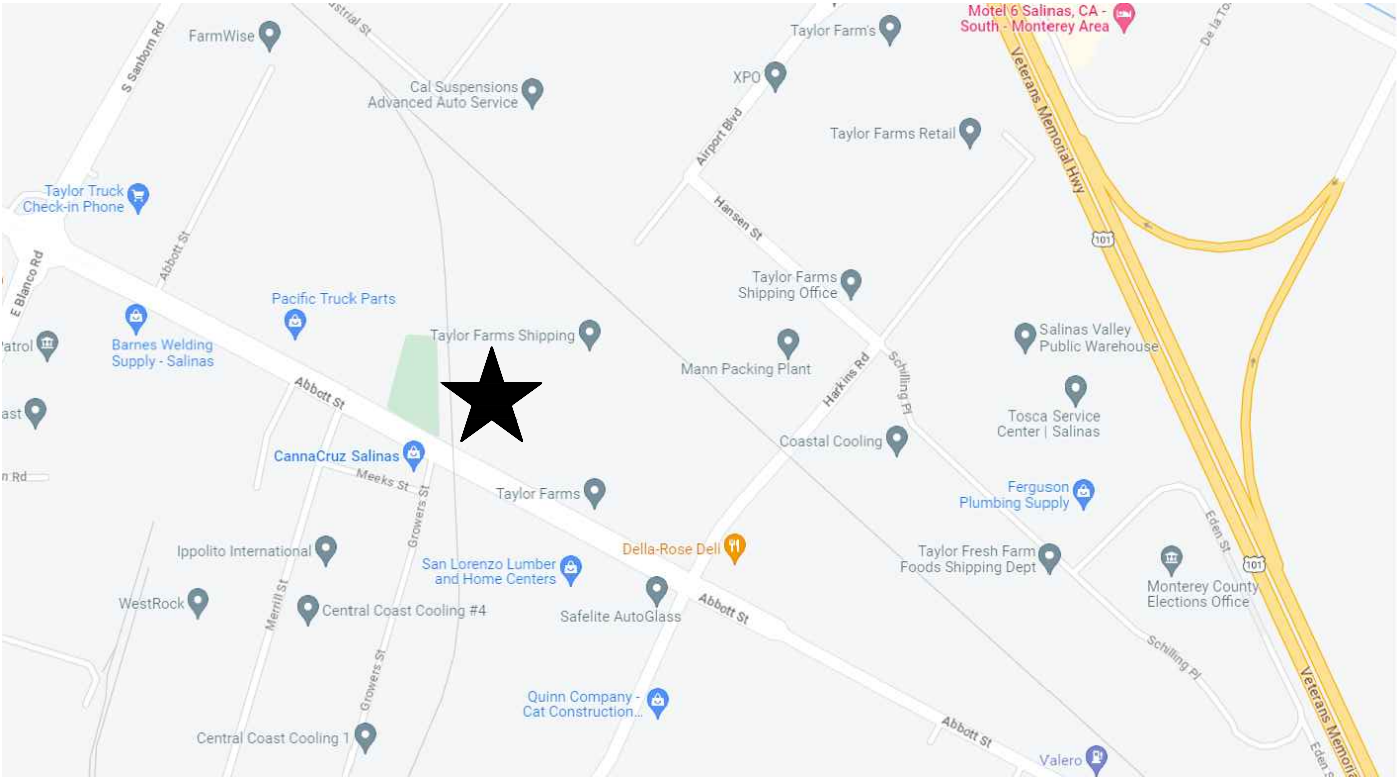

REV	DESCRIPTION	BY	DATE
A	CONSTRUCTION DOCUMENTS	KS	11/16/23
A			
A			
A			
A			

RS LT SAMPLE PLANS

347 CORAL ST, SANTA CRUZ, CA 95060


RoofScreen

ROOFSCREEN MFG., INC.
347 CORAL STREET
SANTA CRUZ, CA 95060
TEL: 831.426.7272
INFO@ROOFSCREEN.COM

ROOFSCREEN COVER SHEET


DRAWN BY:	ML
CHECKED BY:	KS
JOB NUMBER:	5555
SHEET	

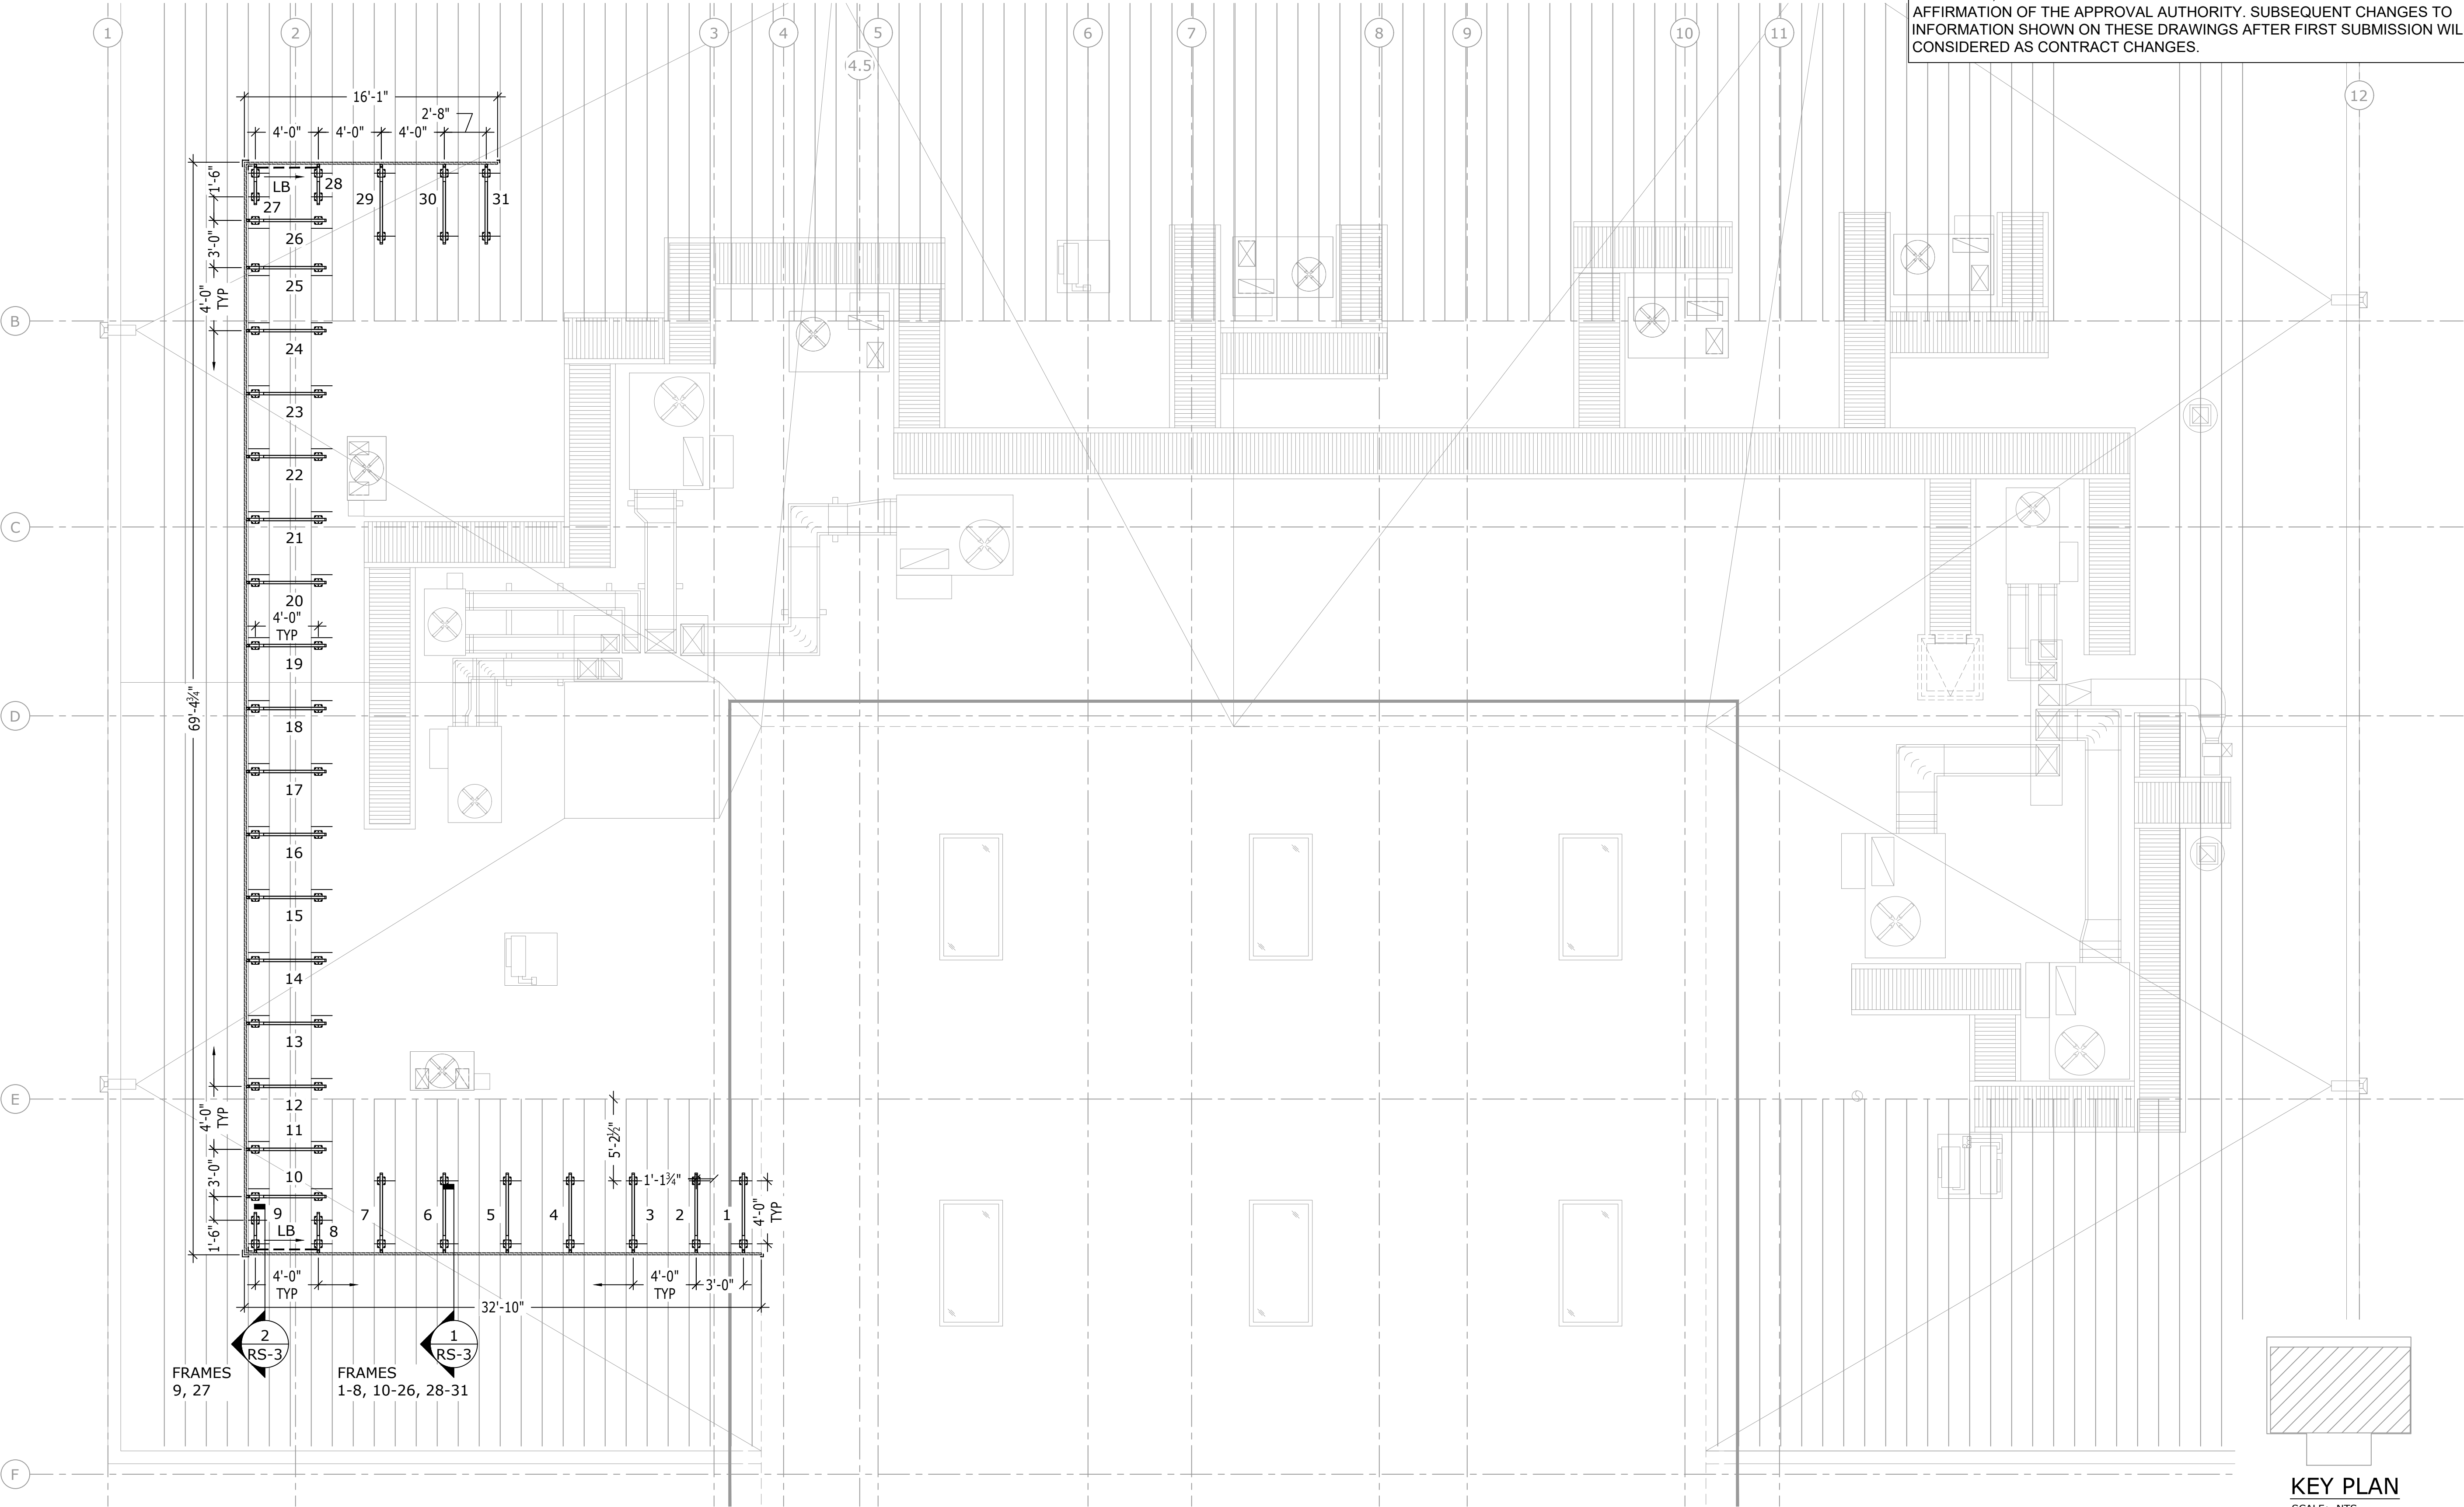RS-0



NOTES:
1. THE ACCURACY OF THE DATA USED TO CREATE THIS LAYOUT HAS NOT BEEN FIELD VERIFIED. THE AS-BUILT LOCATIONS OF ROOF FRAMING MEMBERS AND MECHANICAL EQUIPMENT SHALL BE FIELD VERIFIED. ALL DISCREPANCIES SHALL BE BROUGHT TO THE ATTENTION OF THE ENGINEER PRIOR TO PROCEEDING WITH WORK.
2. NOTIFY THE ENGINEER IF FIELD VERIFIED DIMENSIONS VARY MORE THAN ±3".
3. SEE SHT RS-2 FOR ROOFSCREEN HORIZONTAL PANEL LAYOUT.

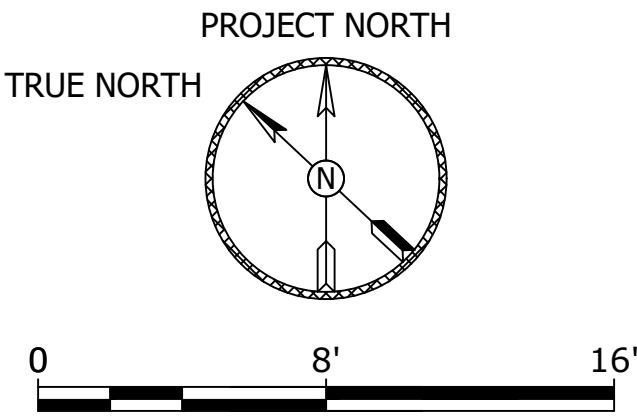ROOFSCREEN FRAMING PLAN
SCALE: 3/16" = 1'



LEGEND	
	ROOFSCREEN LITE FRAME W/ FRAME #
	LATERAL BRACE (DTL 12/RS-4) OFFSET ON PLAN FOR CLARITY ONLY ARROW INDICATES DOWN SLOPE
	HORIZONTAL PANELS
	BLOCKING BY OTHERS UNDER CENTER LINE OF BASE SUPPORT. OFFSET ON PLAN FOR CLARITY ONLY


APPROVAL / REVIEW AUTHORITY:
PLEASE REVIEW THIS DRAWING CAREFULLY. IT REPRESENTS OUR INTERPRETATION OF THE CONTRACT DOCUMENTS HOWEVER, ROOFSCREEN MFG. ASSUMES NO RESPONSIBILITY FOR THE ACCURACY OF THE INFORMATION SHOWN ON THE DESIGN DRAWINGS. THIS IS THE RESPONSIBILITY OF THE BUYER.

UNLESS NOTED OTHERWISE ON THIS DRAWING, WHEN IT IS RETURNED FROM APPROVAL, IT WILL BE ASSUMED THAT ALL INFORMATION SHOWN HEREIN HAS THE AFFIRMATION OF THE APPROVAL AUTHORITY. SUBSEQUENT CHANGES TO INFORMATION SHOWN ON THESE DRAWINGS AFTER FIRST SUBMISSION WILL BE CONSIDERED AS CONTRACT CHANGES.

REV	DESCRIPTION	BY	DATE
Δ	CONSTRUCTION DOCUMENTS	KS	11/16/23

RS LT SAMPLE PLANS	
347 CORAL ST, SANTA CRUZ, CA 95060	
RoofScreen	
ROOFSCREEN MFG., INC. 347 CORAL STREET SANTA CRUZ, CA 95060 TEL: 831.426.7222 INFO@ROOFSCREEN.COM	


ROOFSCREEN FRAMING PLAN	
DRAWN BY:	ML
CHECKED BY:	KS
JOB NUMBER:	5555
SHEET	
RS-1	

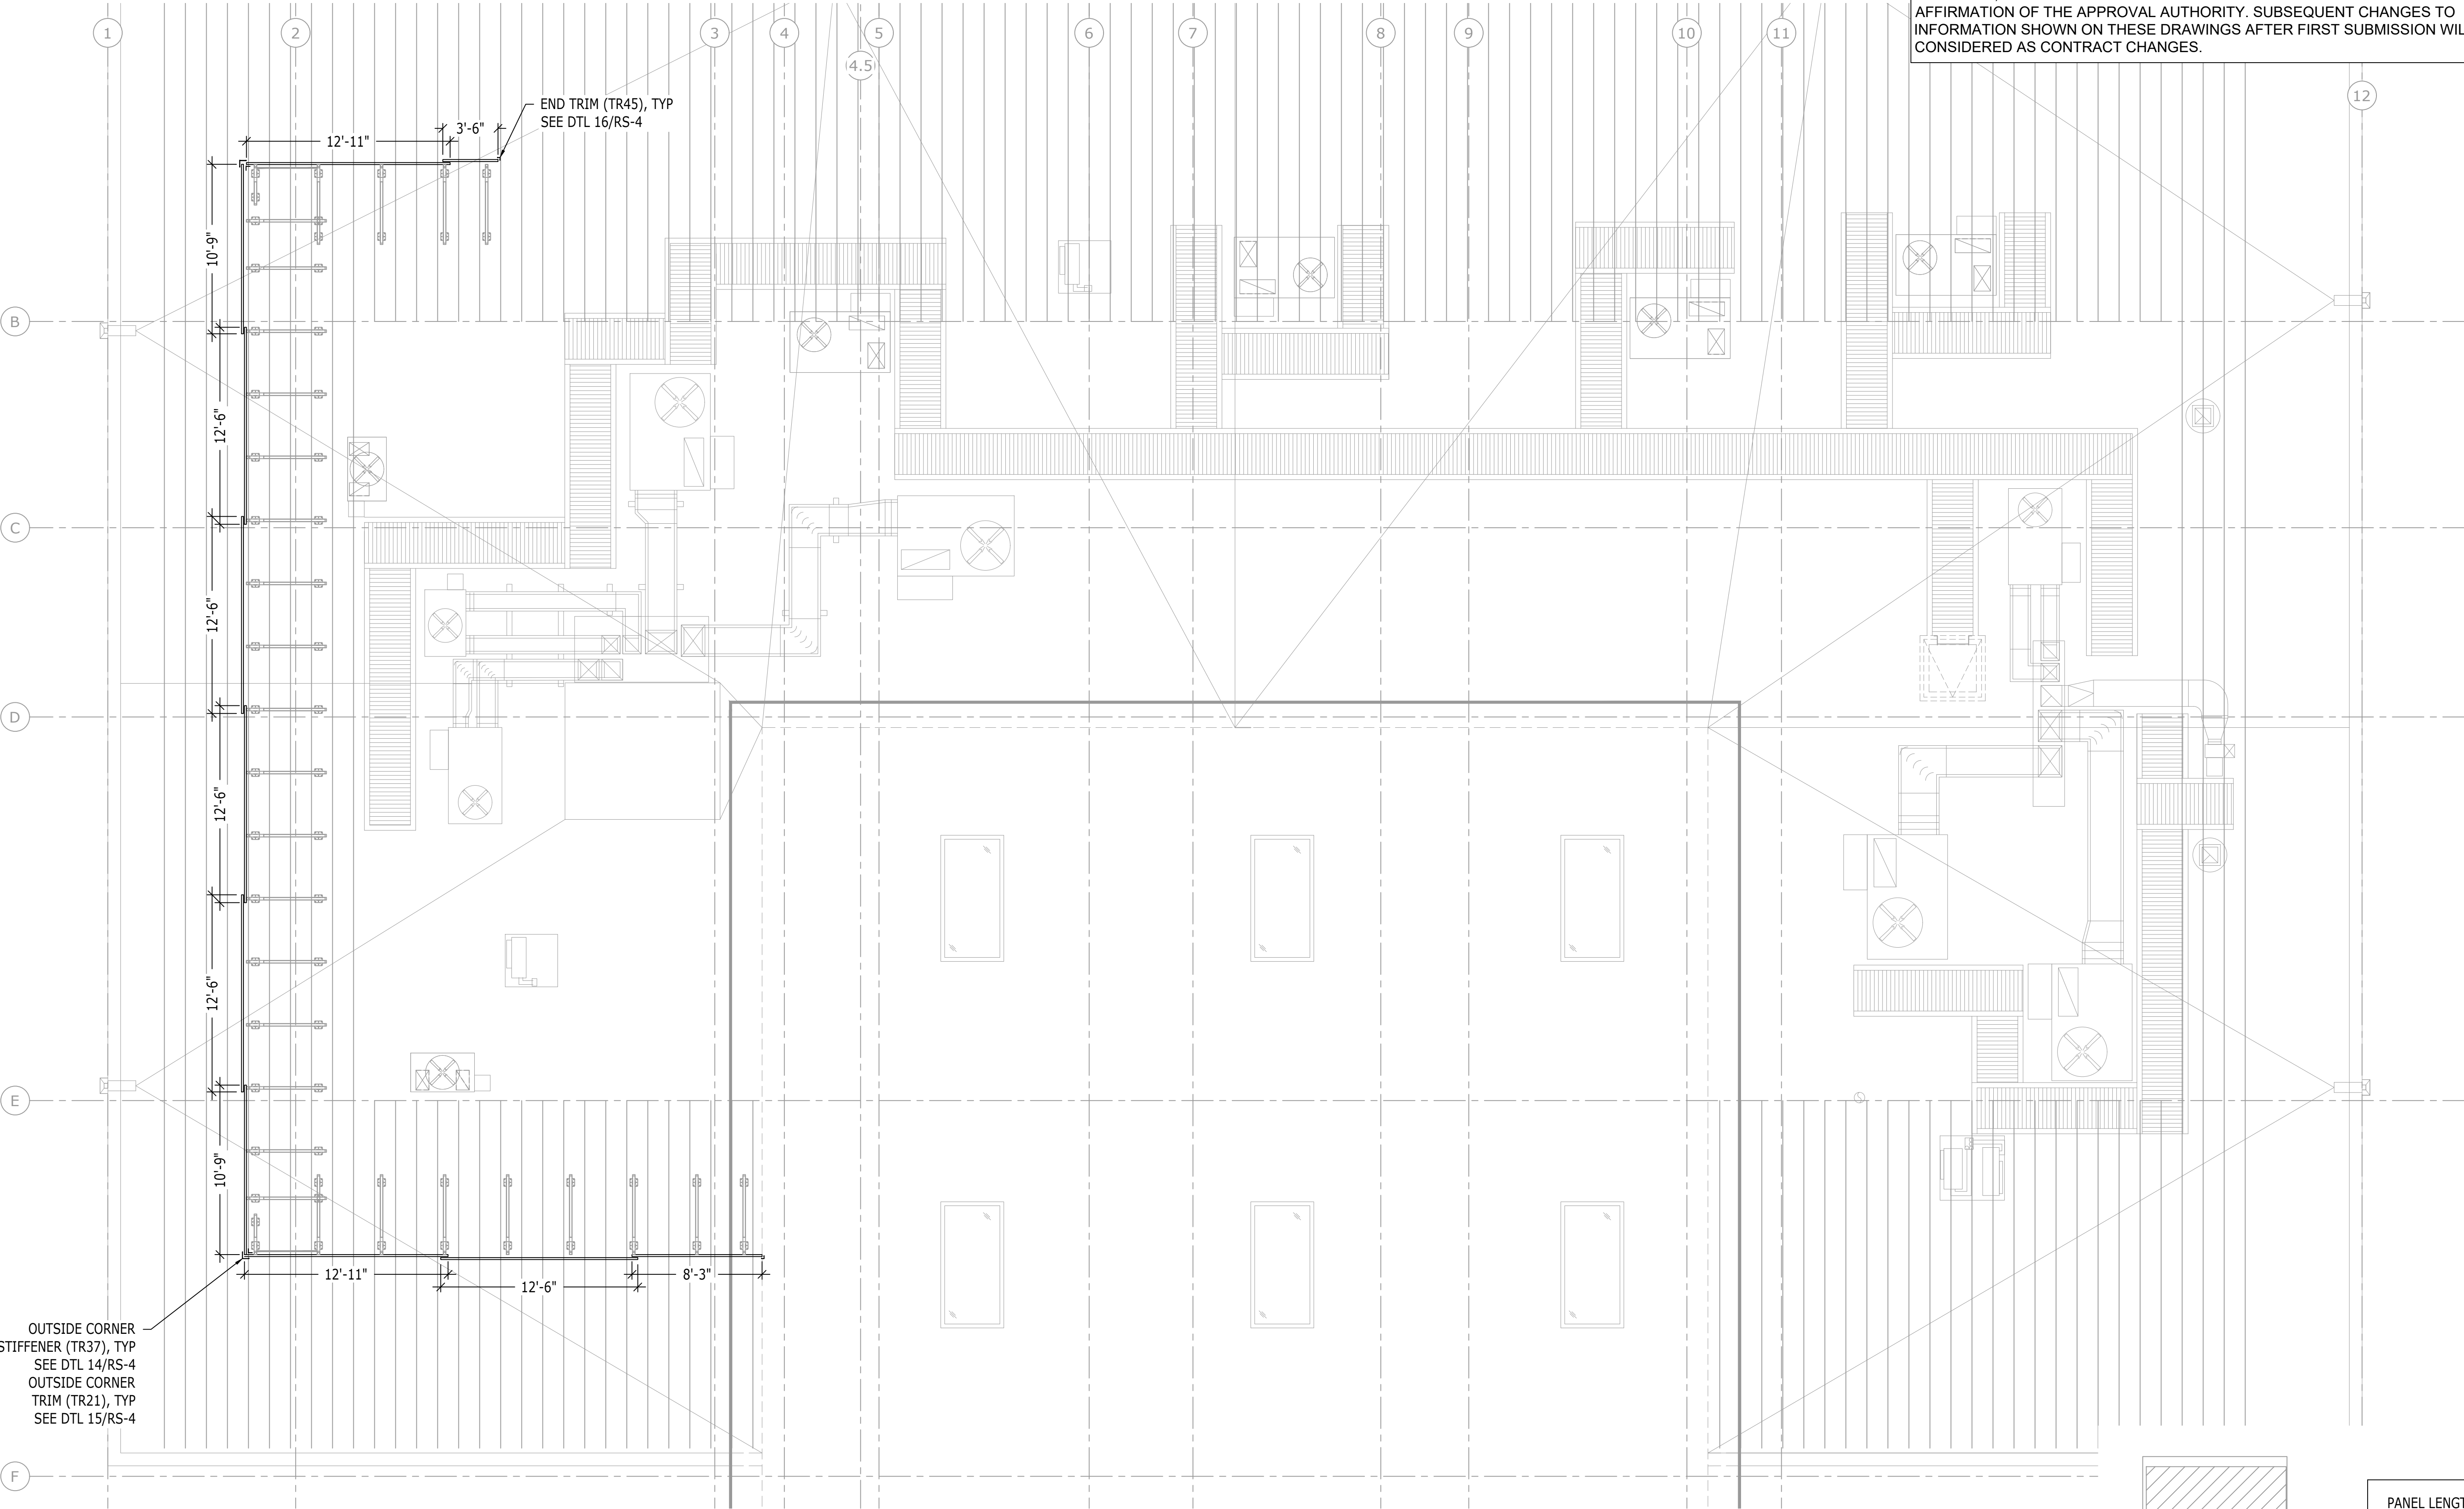


NOTES:
1. THE ACCURACY OF THE DATA USED TO CREATE THIS LAYOUT HAS NOT BEEN FIELD VERIFIED. THE AS-BUILT LOCATIONS OF ROOF FRAMING MEMBERS AND MECHANICAL EQUIPMENT SHALL BE FIELD VERIFIED. ALL DISCREPANCIES SHALL BE BROUGHT TO THE ATTENTION OF THE ENGINEER PRIOR TO PROCEEDING WITH WORK.
2. NOTIFY THE ENGINEER IF FIELD VERIFIED DIMENSIONS VARY MORE THAN ±3".
3. SEE SHT RS-1 FOR ROOFSCREEN FRAMING PLAN.

ROOFSCREEN PANEL PLAN

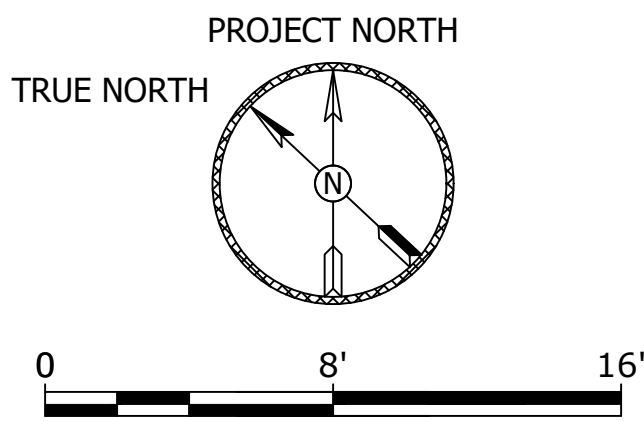SCALE: 3/16" = 1'



APPROVAL / REVIEW AUTHORITY:
PLEASE REVIEW THIS DRAWING CAREFULLY. IT REPRESENTS OUR INTERPRETATION OF THE CONTRACT DOCUMENTS HOWEVER, ROOFSCREEN MFG. ASSUMES NO RESPONSIBILITY FOR THE ACCURACY OF THE INFORMATION SHOWN ON THE DESIGN DRAWINGS. THIS IS THE RESPONSIBILITY OF THE BUYER.
UNLESS NOTED OTHERWISE ON THIS DRAWING, WHEN IT IS RETURNED FROM APPROVAL, IT WILL BE ASSUMED THAT ALL INFORMATION SHOWN HEREIN HAS THE AFFIRMATION OF THE APPROVAL AUTHORITY. SUBSEQUENT CHANGES TO INFORMATION SHOWN ON THESE DRAWINGS AFTER FIRST SUBMISSION WILL BE CONSIDERED AS CONTRACT CHANGES.

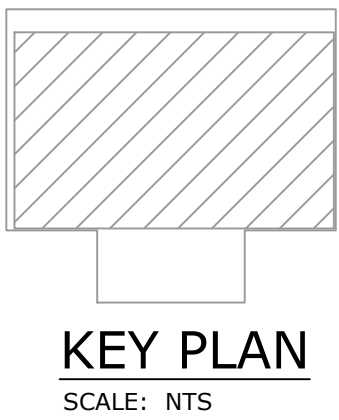

PANEL LENGTHS	
QTY	LENGTHS
4	12'-11"
10	12'-6"
4	10'-9"
2	8'-3"
2	3'-6"

LEGEND
—●— ROOFSCREEN LITE FRAME
—x— HORIZONTAL PANELS AND LENGTH "X" PER PLAN, SEE PANEL LENGTH TABLE. OFFSET FOR CLARITY ONLY.

REV	DESCRIPTION	BY	DATE
Δ	CONSTRUCTION DOCUMENTS	KS	11/16/23

RS LT SAMPLE PLANS	
347 CORAL ST, SANTA CRUZ, CA 95060	
RoofScreen	
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ROOFSCREEN PANEL PLAN
DRAWN BY: ML
CHECKED BY: KS
JOB NUMBER: 5555
SHEET
RS-2

- ALL WORK SHALL BE PERFORMED EXCLUSIVELY BY TRAINED COMPETENT PERSONNEL AND SHALL COMPLY WITH ALL APPLICABLE SAFETY LAWS, REGULATIONS, PROGRAMS AND PRACTICES TO ENSURE THE SAFETY OF ALL PEOPLE LOCATED ON THE WORK SITE.
2. TOP OF SCREEN ELEVATION SHALL BE UNIFORM ALONG FULL LENGTH OF WALL AND SHALL NOT EXCEED MAX ELEVATION SHOWN.
3. FRAME DIMENSIONS SHOWN ARE FOR THE TALLEST FRAME WHERE THE ROOF IS AT ITS LOWEST ELEVATION. FRAME TUBES WILL BE PRE-CUT AND DELIVERED TO THESE DIMENSIONS. FRAMES INSTALLED WHERE ROOF IS AT HIGHER ELEVATIONS MAY REQUIRE FIELD TRIMMING OF THE VERTICAL AND DIAGONAL TUBE LENGTHS TO KEEP TOP OF SCREEN ELEVATION LEVEL.
4. LASER MEASURING IS RECOMMENDED PRIOR TO FIELD CUTTING.
5. ENSURE SQUARE POST SUPPORTS ARE CENTERED ON EXISTING BLOCKING (BY OTHERS).
6. INSTALL FRONT SQUARE POST SUPPORTS IN A STRAIGHT LINE USING LASER LEVEL OR STRING LINE. THERE IS NO FRONT TO BACK ADJUSTMENT FOR THE FRAME CONFIGURATION USED ON THIS PROJECT.
7. WHEN USING SELF-DRILLING TEK SCREWS TO FASTEN BASE SUPPORTS THROUGH WOOD DECKING TO STEEL STRUCTURAL MEMBERS BELOW, IT IS NECESSARY TO DRILL A CLEARANCE HOLE, LARGER THAN THE DIAMETER OF THE TEK SCREW, IN THE WOOD DECKING TO ALLOW THE SCREW TO SPIN AT THE PROPER SPEED TO DRILL INTO THE STEEL BELOW. IT IS NOT NECESSARY OR RECOMMENDED TO DRILL A PILOT HOLE IN THE STEEL MEMBER.
8. TO REDUCE THE POSSIBILITY OF CONDENSATION, FILL SQUARE POST SUPPORTS WITH UNFACED BATT INSULATION (SUPPLIED BY OTHERS) DURING INSTALLATION.
9. THE CONTRACTOR SHALL BE RESPONSIBLE FOR THE WATER-TIGHTNESS OF THE EXISTING ROOF DECK. FLASHING AND ROOFING OF BASE SUPPORTS SHALL BE PER ROOFING SYSTEM MANUFACTURER'S REQUIREMENTS. VERIFICATION OF COMPLIANCE WITH ROOF WARRANTY AND PRE-APPROVAL FROM ROOFING SYSTEM MANUFACTURER, IF REQUIRED, SHALL BE PERFORMED BY OTHERS.
10. ROOF FLASHING BOOTS SHALL TERMINATE 4" MIN FROM TOP OF SQUARE POST SUPPORTS.
11. APPROPRIATE CARE SHALL BE TAKEN TO ELIMINATE THE POSSIBILITY OF DAMAGE TO EXISTING DECK AND ROOFING SYSTEM. CONSTRUCTION MATERIALS SHALL NOT BE STORED ON THE ROOF DECK UNLESS APPROPRIATE MEASURES ARE TAKEN TO PROTECT THE ROOF FROM DAMAGE.
12. MANY OF THE FRAME CONNECTOR FITTINGS HAVE EXTRA SCREW HOLES. SEE ROOFSCREEN SPECIFICATIONS ON THIS SHEET FOR THE CORRECT NUMBER OF SCREWS PER FITTING.
13. OVERLAP PANEL RIBS AS REQUIRED TO ACHIEVE CORRECT PANEL HEIGHT AS SHOWN IN FRAME DETAIL(S) 1, 2/RS-3.
14. AFTER ROOFSCREEN PANELS ARE INSTALLED, ATTACH TRIM TO PANELS WITH COLOR-MATCHED SELF-DRILLING SCREWS AT 12" O.C. ALONG EACH LEG OF TRIM AT CORNERS AND ALONG SINGLE LEG AT ENDS, AND AT 3'-0" O.C. ALONG CAP TRIM PER DTL 16/RS-4.
15. APPLY ANTI-SEIZING LUBRICANT TO ALL STAINLESS BOLTS DURING INSTALLATION TO PREVENT GALLING.
16. AFTER INSTALLATION IS COMPLETE, DUST OFF AND REMOVE ALL METAL SHAVINGS FROM BASE CAPS AND FINISHED ROOF SURFACE TO PREVENT SURFACE RUST AND STAINING.
17. TEK SCREWS ARE FULLY SEATED WHEN THE HEAD IS FLUSH WITH THE WORK SURFACE. OVERDRIVING MAY RESULT IN TORSIONAL FAILURE OF TEK SCREWS OR STRIP OUT OF THE SUBSTRATE. SCREW GUN SHOULD BE A MINIMUM OF 6 AMPS AND HAVE AN RPM RANGE OF 0-2500.

P) PANEL: 7.2 RIB 1½" DEEP, 24ga, TWO HORIZONTAL ROWS, FASTEN TO VERTICAL TUBE SECTION W/ COLOR-MATCHING #12-14 X 1" LONG T/3 "TEK" SCREW W/ NEOPRENE WASHER - ROOFSCREEN P/N "S16", (1) TOTAL PER DOWN FLUTE, PER DTL 13/RS-4, AND PER MANUFACTURER'S SPECS. DEFLECTION LIMIT = L/180

14.1) HSS 1.75 OD X 1.75 (14ga), $F_y = 50 \text{ ksi}$

PROPRIETARY CONNECTORS:

42.1) SQUARE TO FLAT CONNECTOR:
CONN TO SQUARE HORIZ TUBE W/ #12-14 X 1" LONG T/3 "TEK" SCREWS -
ROOFSCREEN P/N "S10", (2) PER FLANGE MIN, MINIMUM (8) TOTAL.
CONN TO END OF SQUARE DIAGONAL TUBE THRU PRE-DRILLED HOLE W/ Ø $\frac{5}{16}$ " X
3" SS BOLT - P/N B38, Ø $\frac{5}{16}$ " SS FLAT WASHER - P/N W18, Ø $\frac{5}{16}$ " SS LOCKWASHER -
P/N W24, AND SS NUT - P/N N12. (1) TOTAL PER DTL 17/RS-4.

SPS SQUARE POST SUPPORT: 28" HIGHS
CONNECT TO <E> DOUBLED 1400S162-97 STRUCTURAL STUD BLOCKING
(DESIGNED AND SUPPLIED BY OTHERS) W/ #14-20 x 4" T/5 SELF-DRILLING "TEK"
SCREW - ROOFSCREEN P/N "S13", (4) TOTAL PER SPS DTL 2/RS-4. ALIGN BASE
SUPPORT W/ CENTERLINE OF EXISTING BLOCKING.

EVALUATION OF THE EXISTING ROOF SHEATHING, ROOF FRAMING AND BUILDING FOR NEW MECHANICAL EQUIPMENT AND SCREEN LOADS (INCLUDING SNOW DRIFT LOADING EFFECTS) SHALL BE PERFORMED BY OTHERS. AS REQUIRED PER EVALUATION, REINFORCEMENT SHALL BE PROVIDED BY OTHERS. ANALYSIS SHALL BE DONE BY A LICENSED PROFESSIONAL ENGINEER. ROOFSCREEN REACTIONS PROVIDED ARE BASED ON THE DESIGN CRITERIA ON SHEET RS-0. THE MAXIMUM ALLOWABLE STRESS DESIGN (0.6 FACTOR APPLIED TO WIND LOAD) REACTIONS AT THE BASE ARE AS FOLLOWS:

R1 Rx=±xxx lbs SHEAR AND Ry=±xxx lbs TENSION/COMPRESSION AND Mz=±xxx ft-lbs MOMENT

R2 Rx=±xxx lbs SHEAR AND Ry=±xxx lbs TENSION/COMPRESSION AND Mz=±xxx ft-lbs MOMENT

R3 Rx=±xxx lbs SHEAR AND Ry=±xxx lbs TENSION/COMPRESSION AND Mz=±xxx ft-lbs MOMENT

R4 Rx=±xxx lbs SHEAR AND Ry=±xxx lbs TENSION/COMPRESSION AND Mz=±xxx ft-lbs MOMENT

R1 Rx=xxx lbs SHEAR AND Ry =xxx lbs COMPRESSION

R2 Rx=xxx lbs SHEAR AND Ry =xxx lbs COMPRESSION

R3 Rx=xxx lbs SHEAR AND Ry =xxx lbs COMPRESSION

R4) $R_x = \text{xxx lbs SHEAR}$ AND $R_y = \text{xxx lbs COMPRESSION}$

R EXISTING ROOF FRAMING: $2\frac{3}{32}$ " PLYWOOD DECK OVER DOUBLED 1400S162-97 STRUCTURAL STUDS.

ALL OTHER ARRANGEMENTS REQUIRE ENGINEER'S APPROVAL.



















SCALE: NTS FRAMES 1-7, 10-26, 29-31



SCALE: NTS FRAMES 8, 9, 27, 28

RS LT SAMPLE PLANS 347 CORAL ST, SANTA CRUZ, CA 95060		ROOFSCREEN MFG., INC. 347 CORAL STREET SANTA CRUZ, CA 95060 (866) 766-3727 INFO@ROOFSCREEN.COM	
ROOFSCREEN FRAME DETAILS & SPECIFICATIONS		RS LT SAMPLE PLANS	
DRAWN BY: ML		BY DATE	
CHECKED BY: KS		CONSTRUCTION DOCUMENTS	
JOB NUMBER: 5555		11/16/23	
SHEET		Δ	
RS-3		Δ	

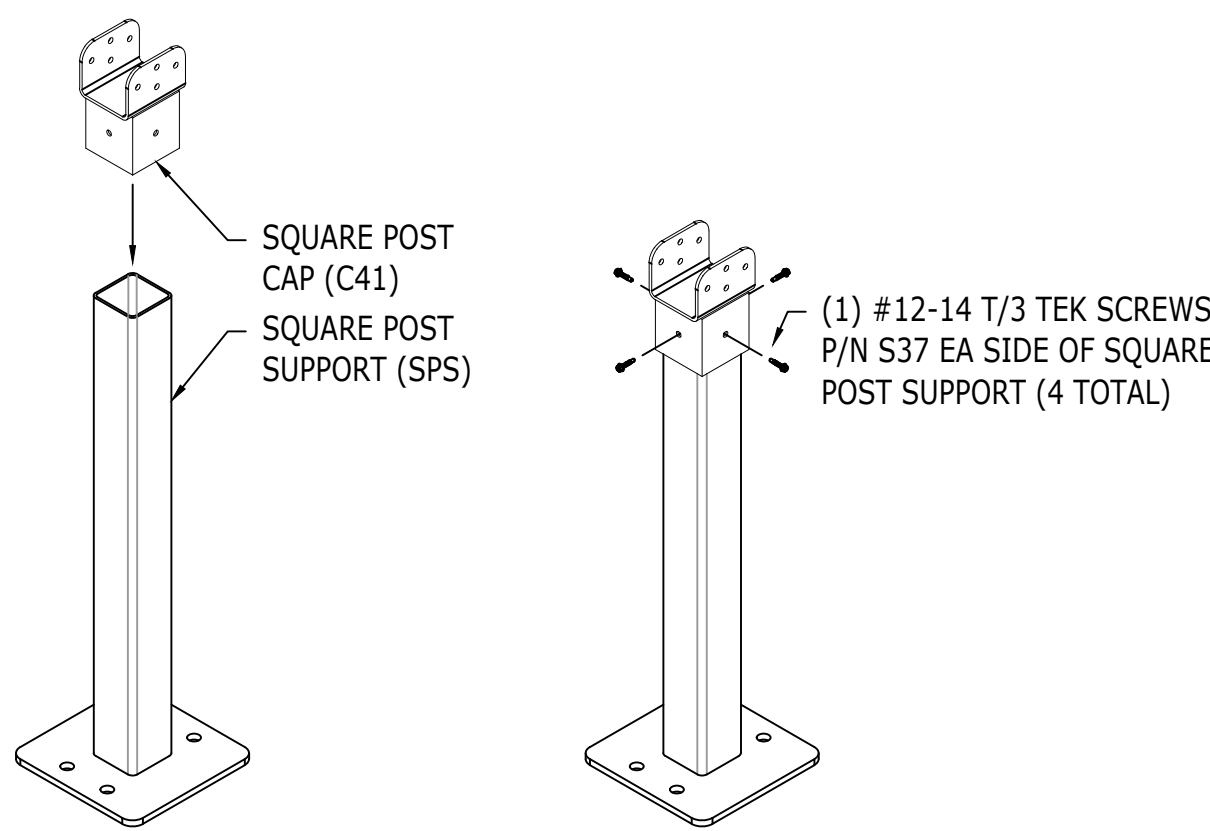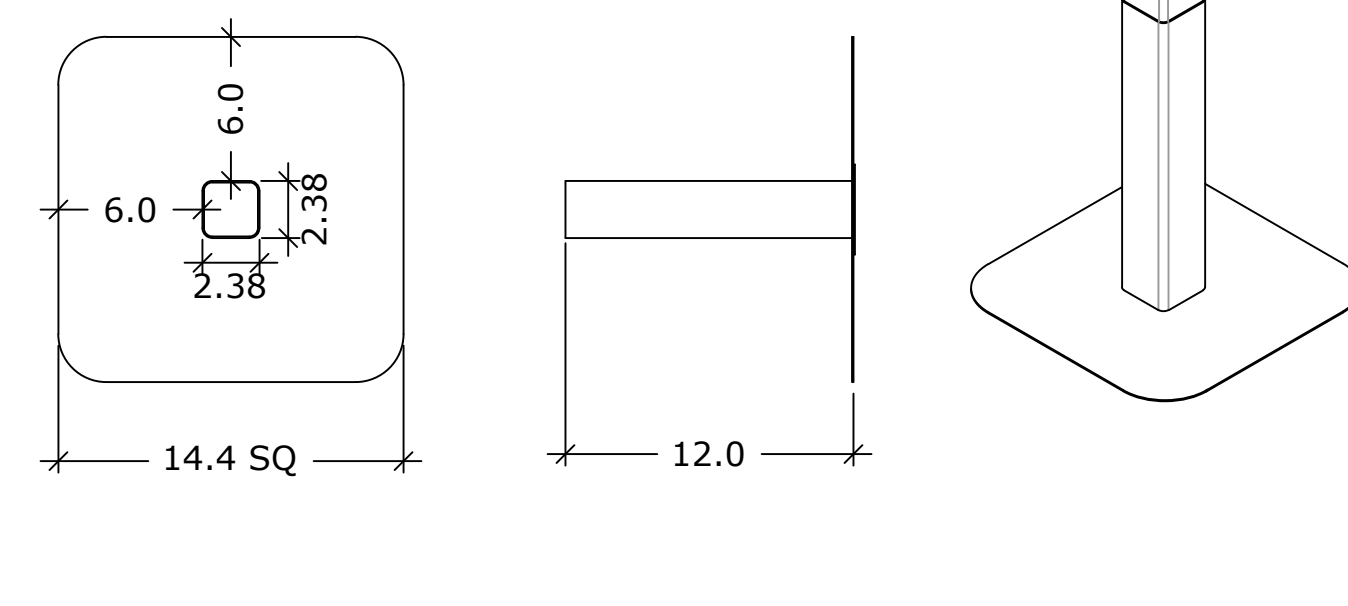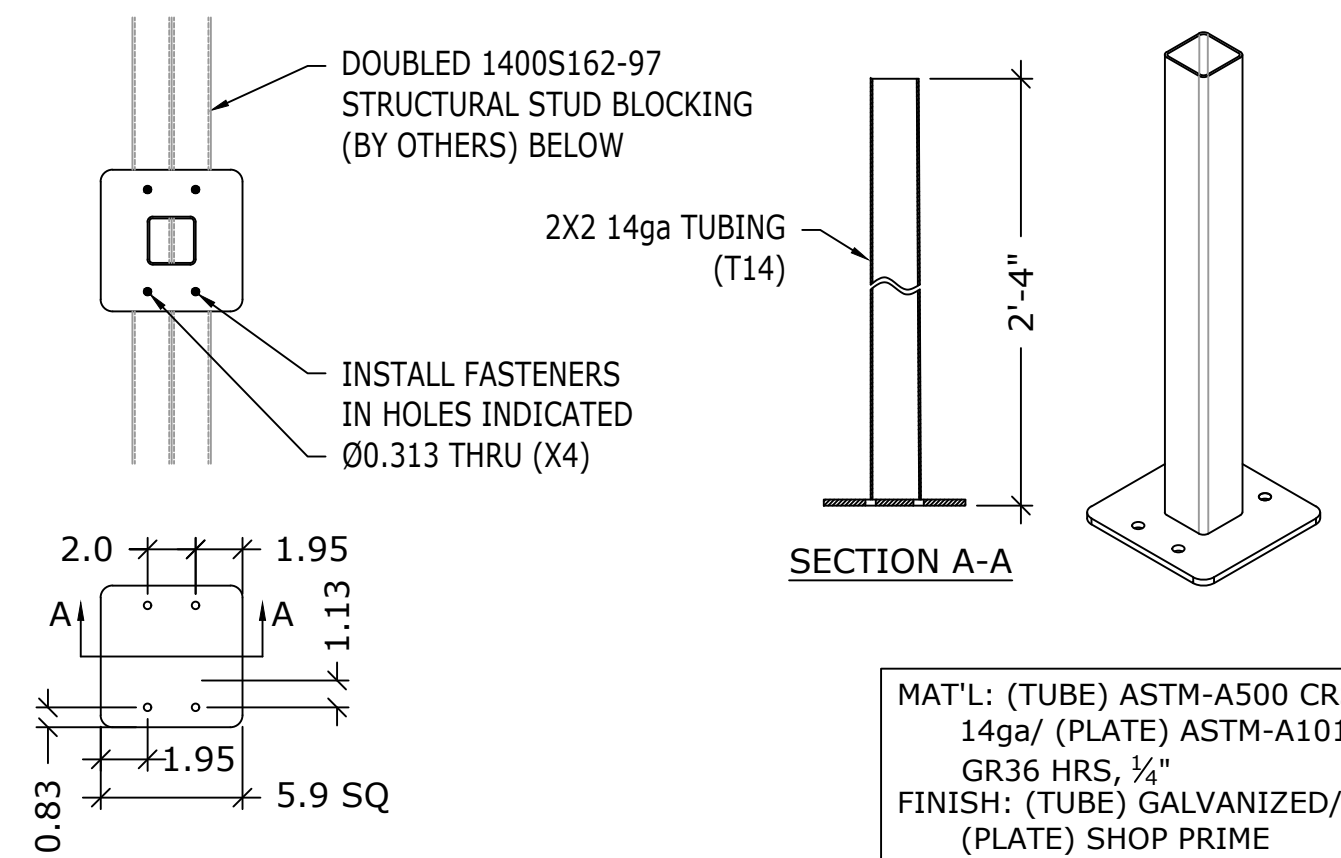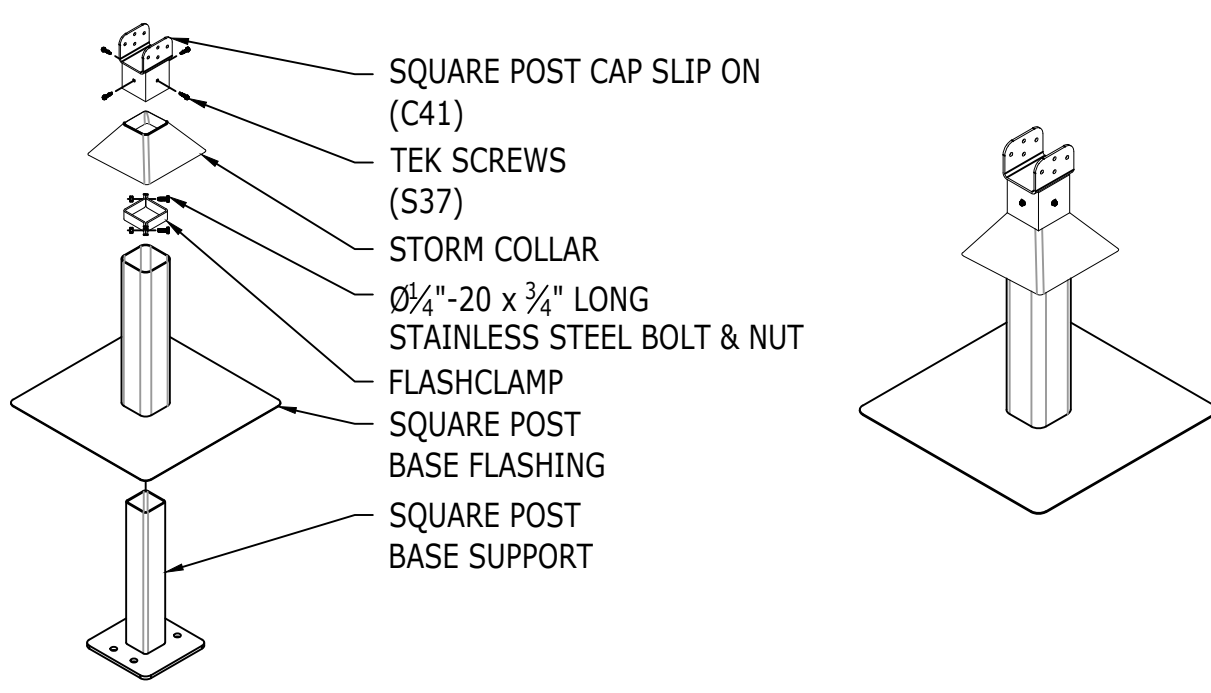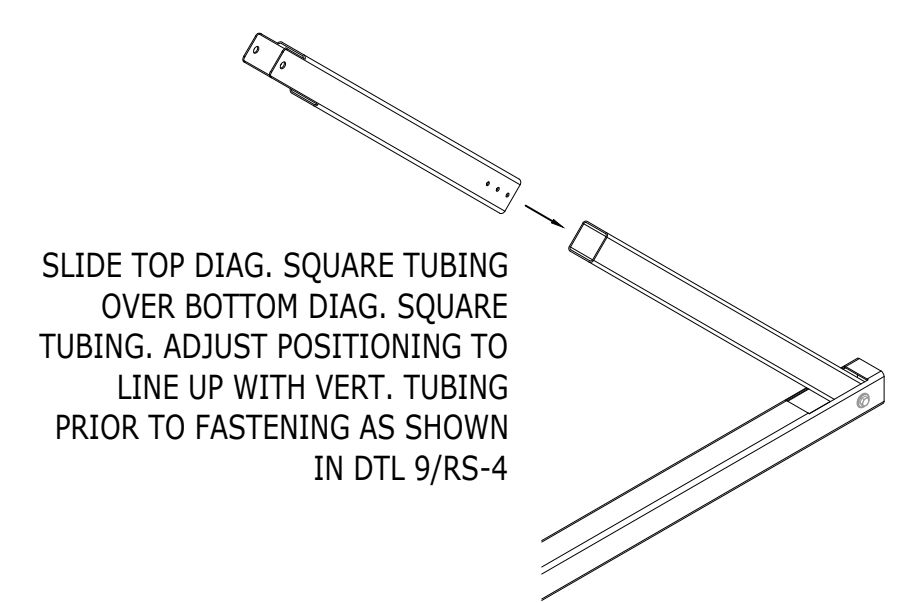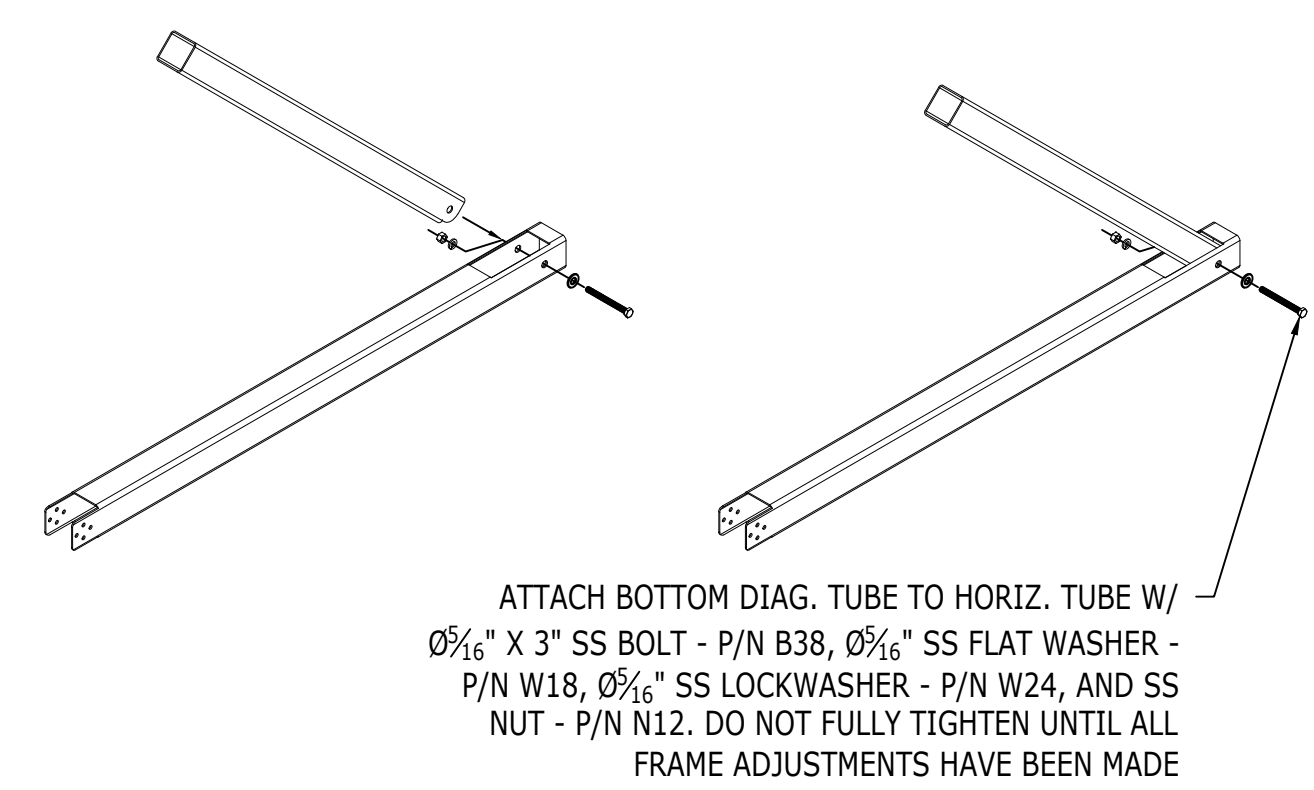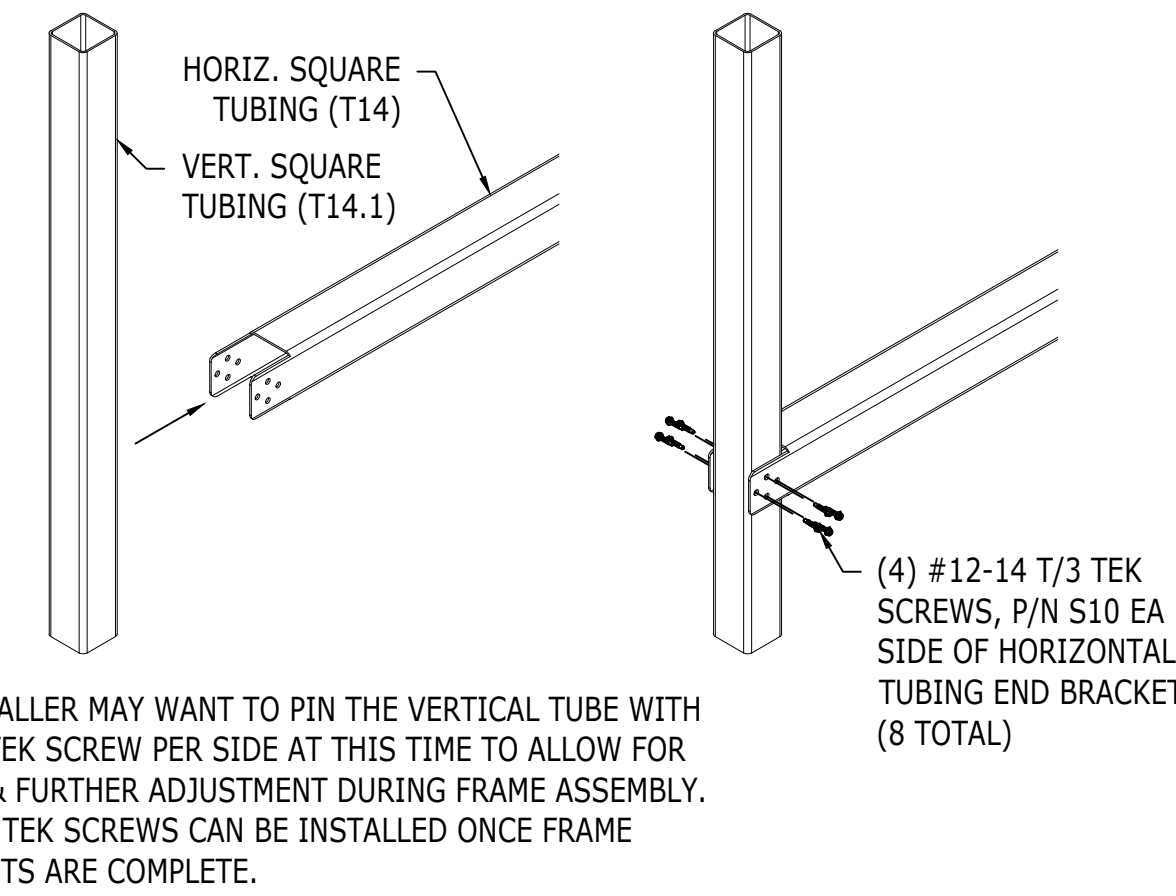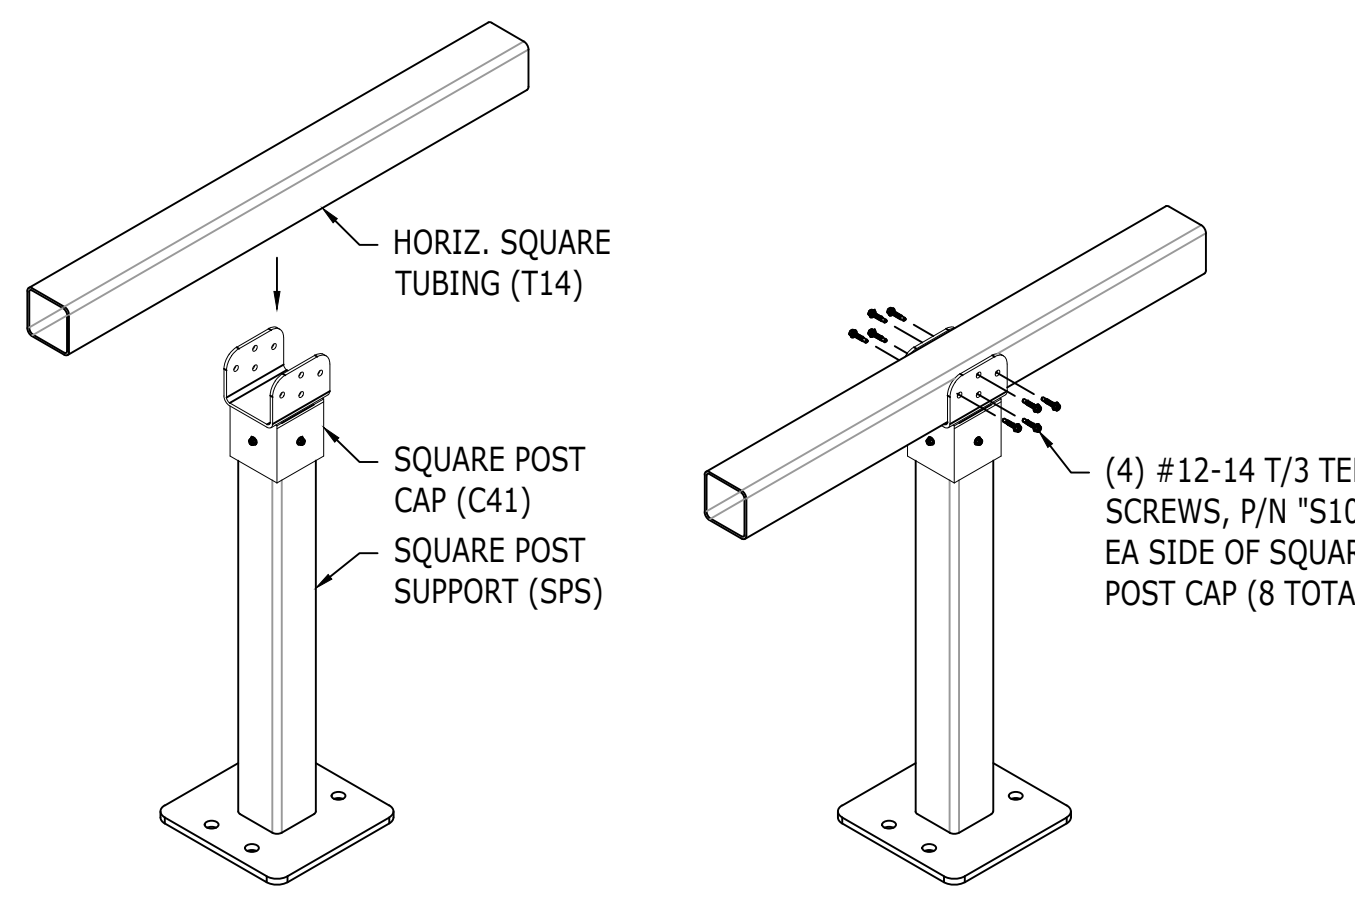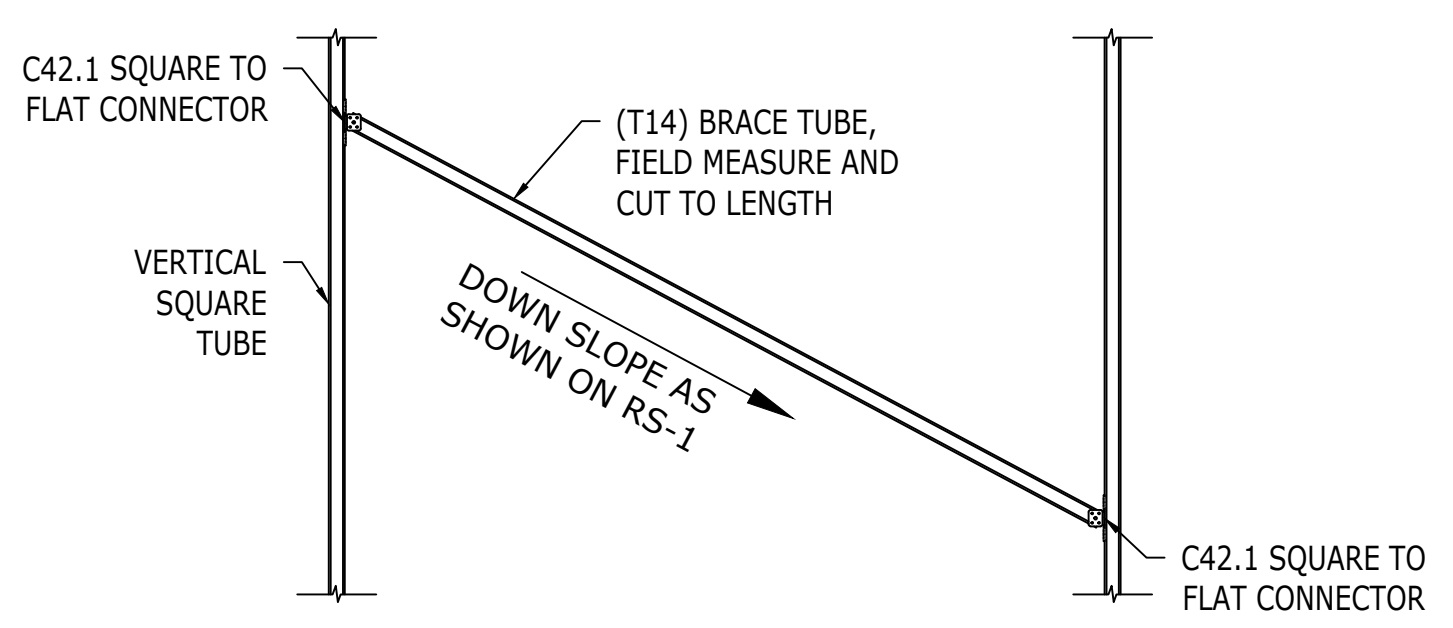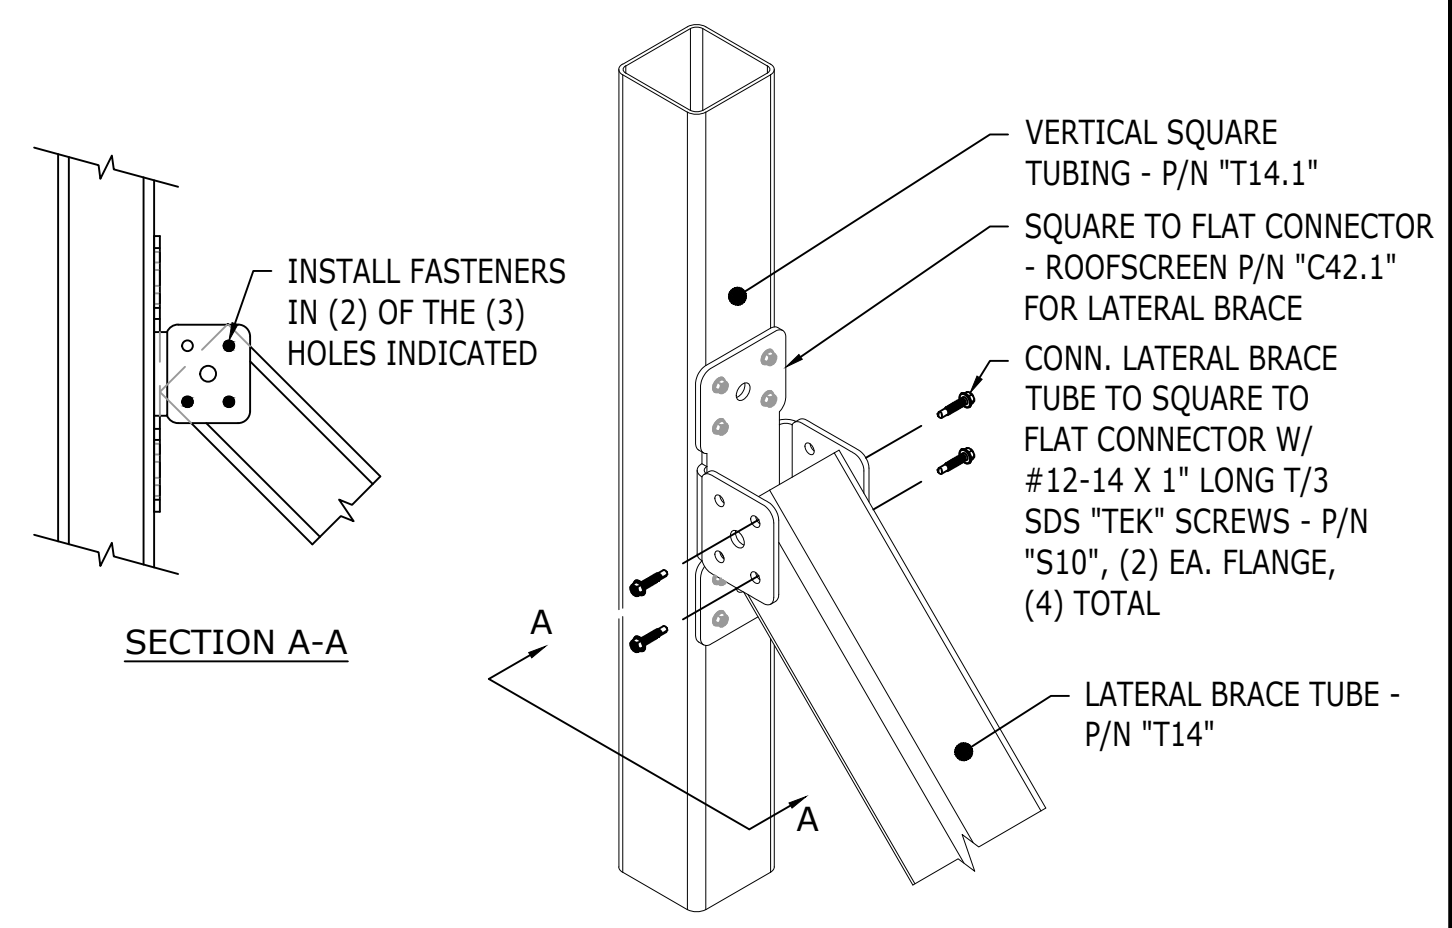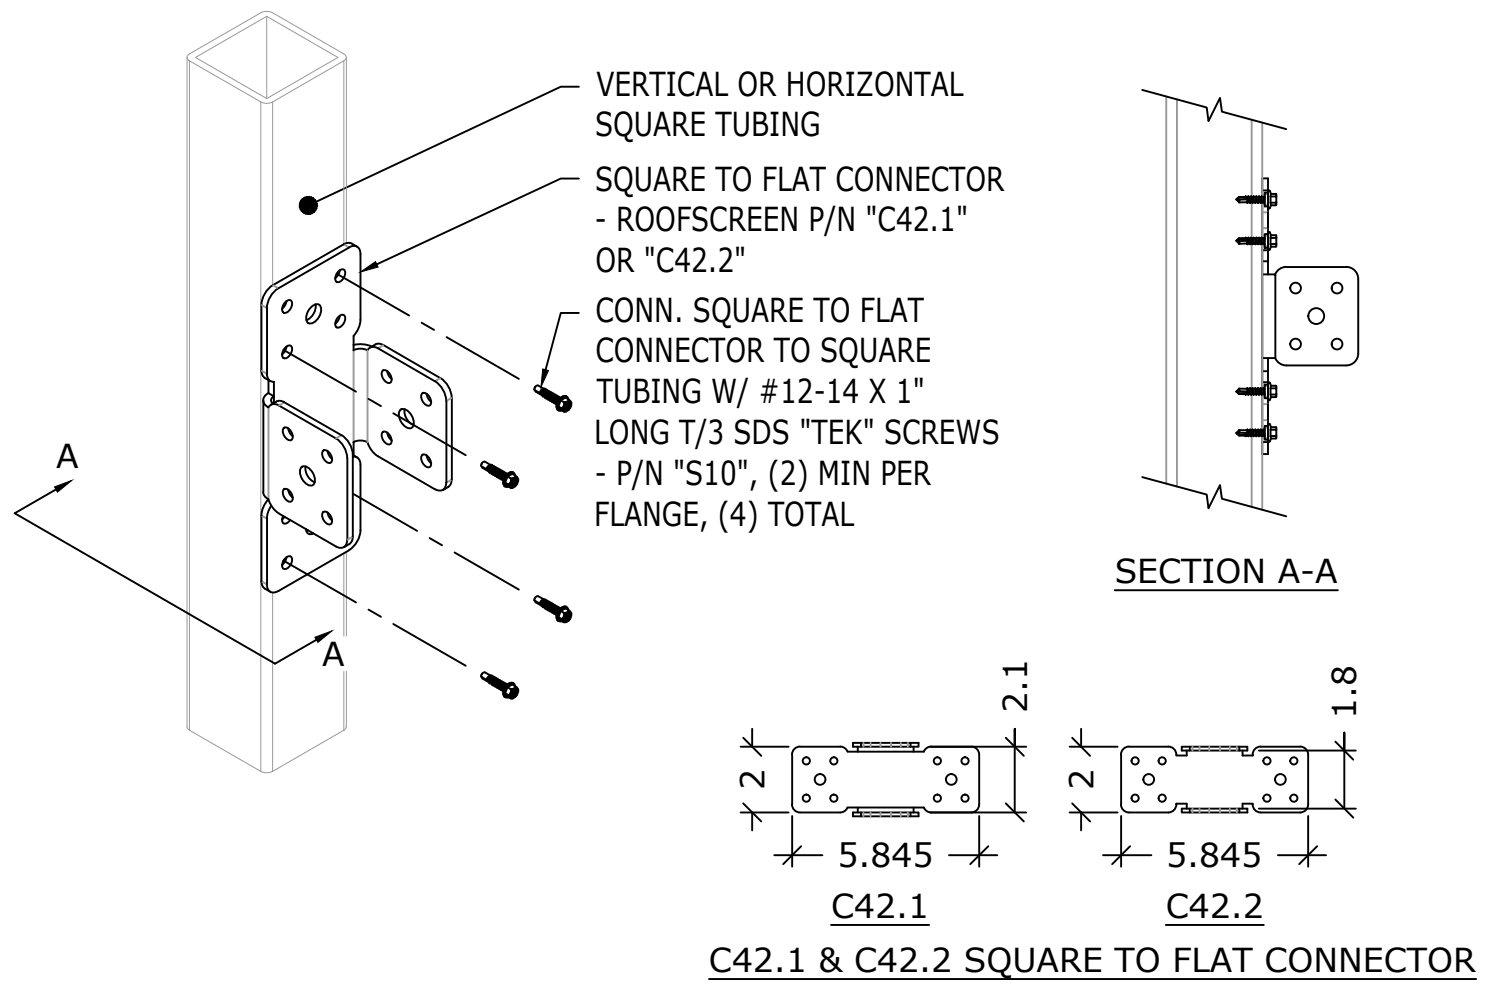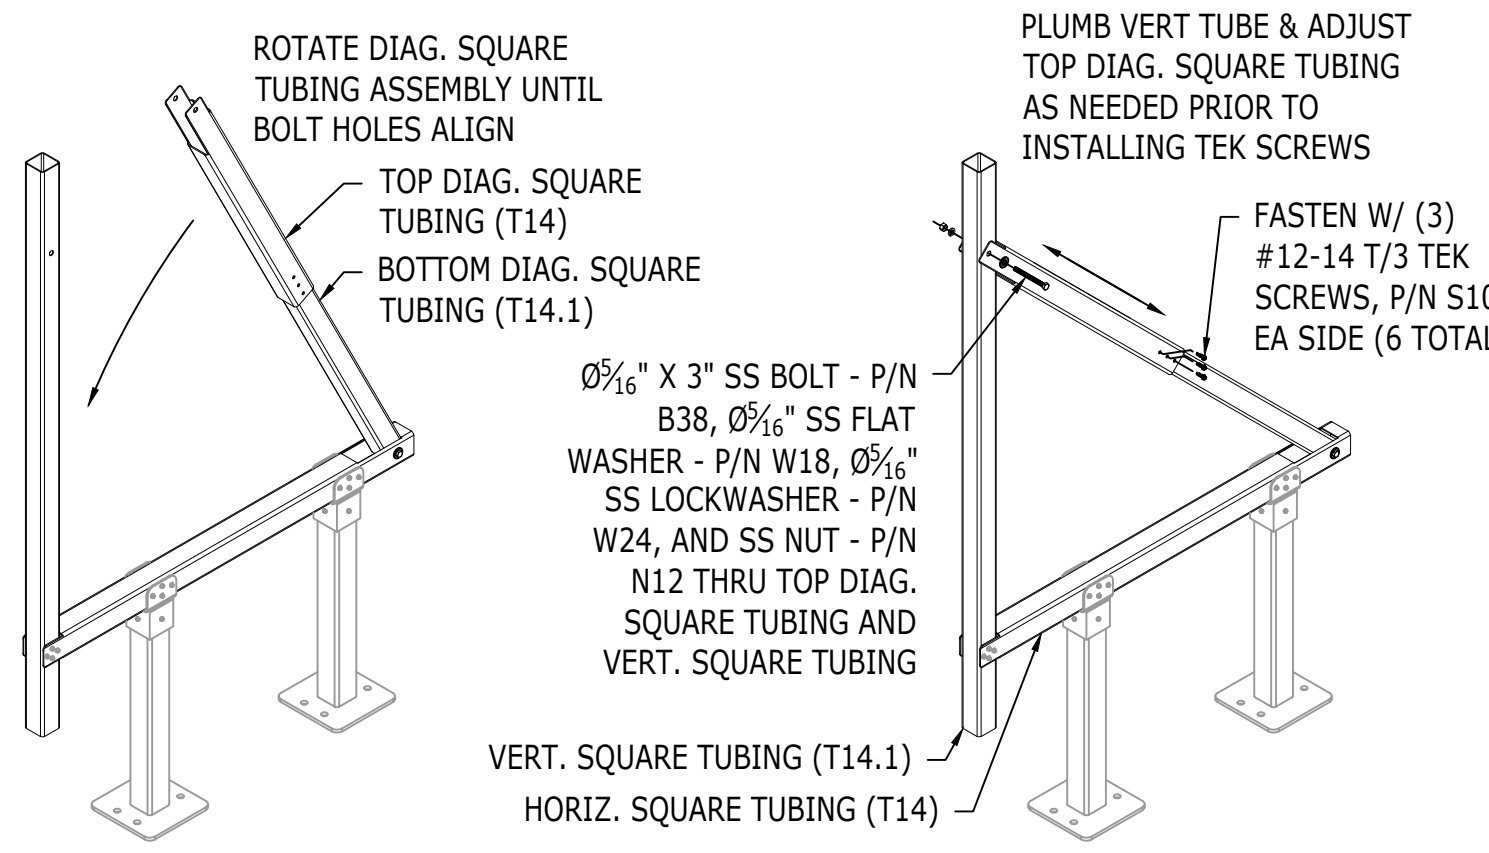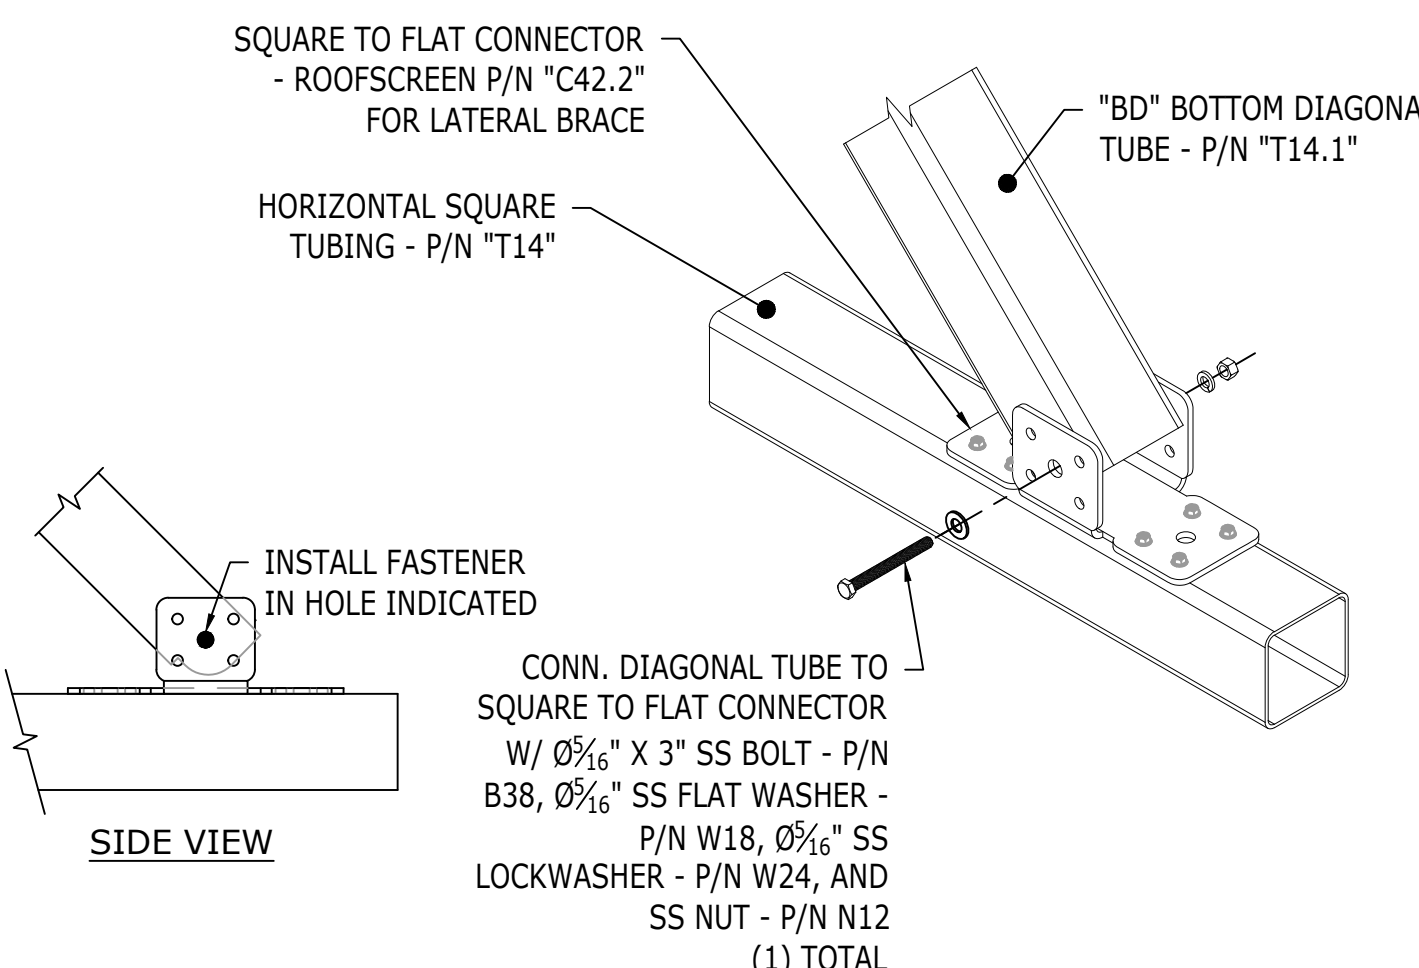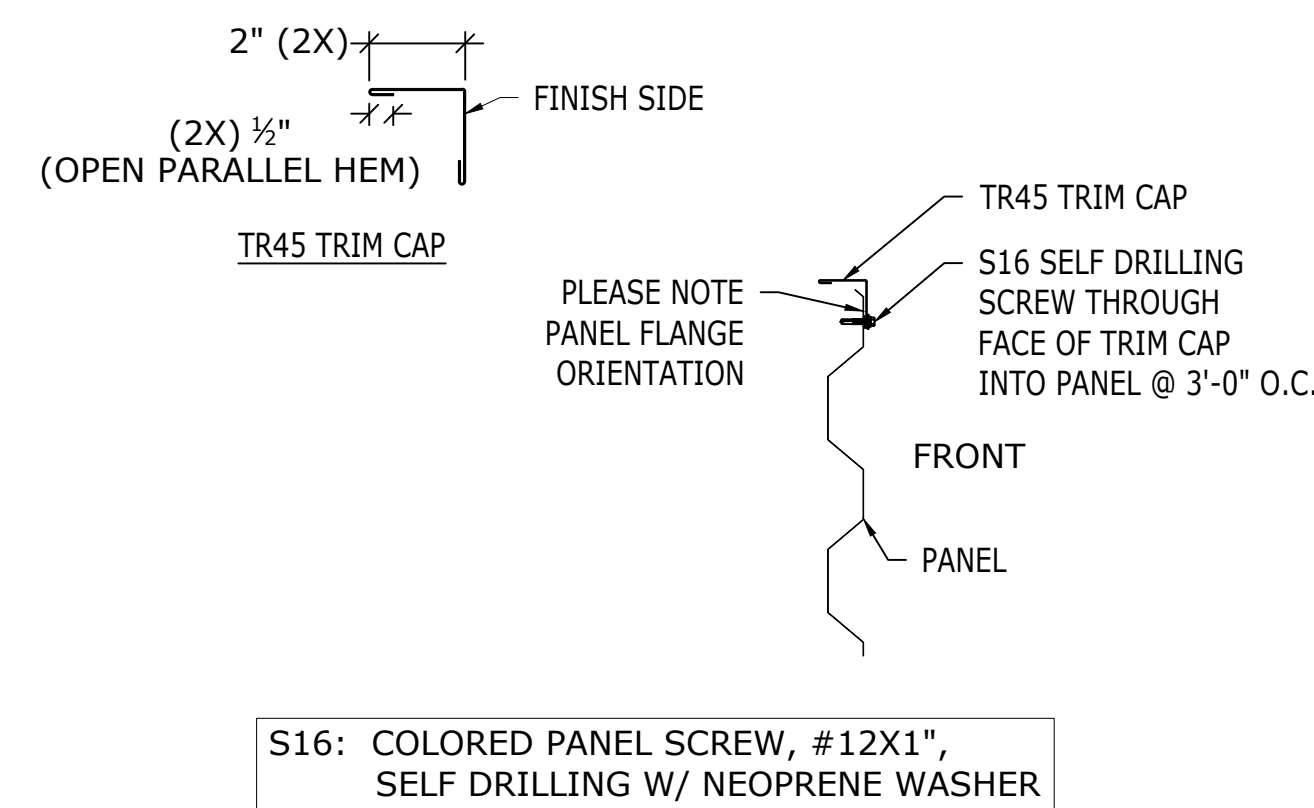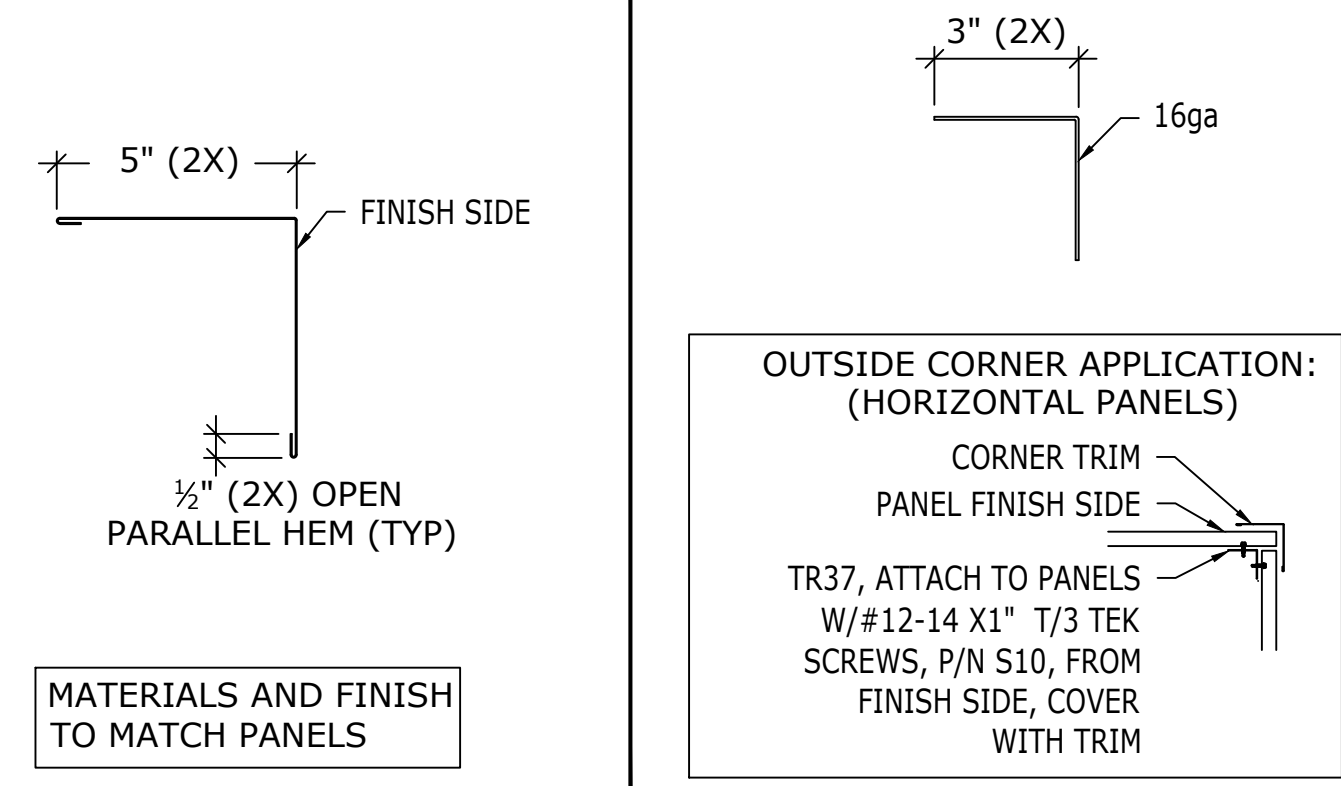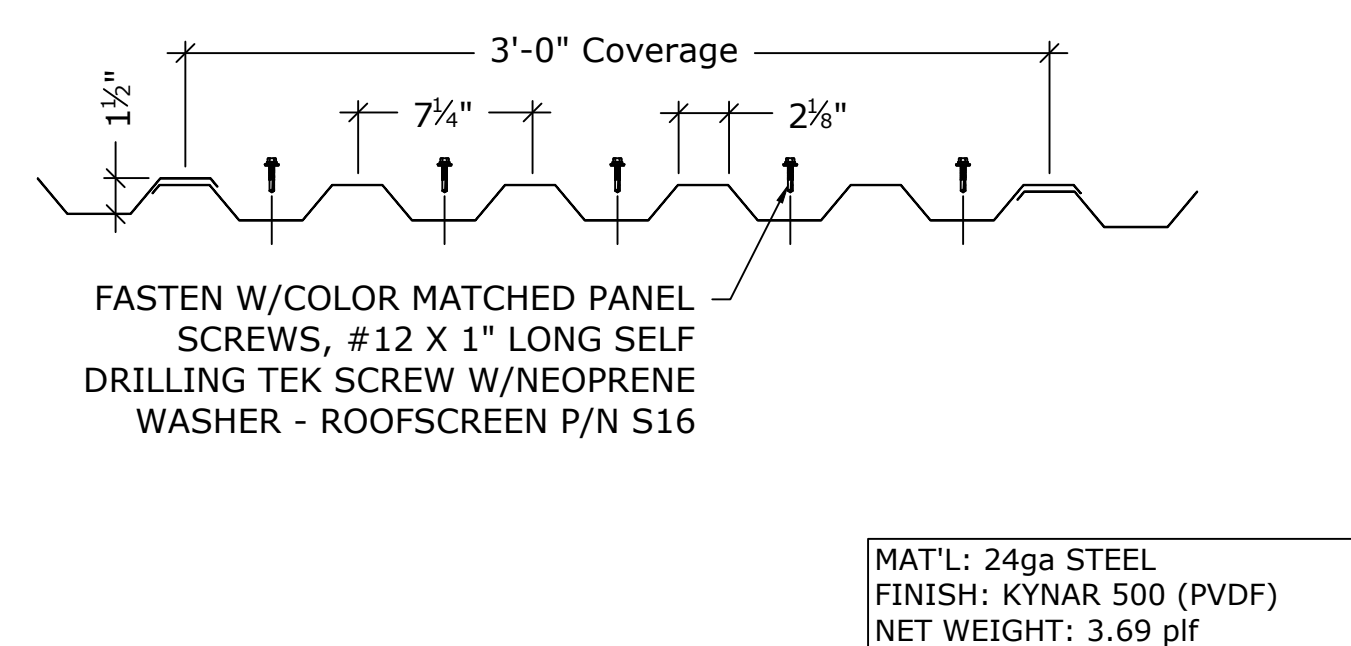 <p>SQUARE POST CAP (C41) SQUARE POST SUPPORT (SPS)</p> <p>(1) #12-14 T/3 TEK SCREWS, P/N S37 EA SIDE OF SQUARE POST SUPPORT (4 TOTAL)</p>		 <p>MAT'L: 60mil, TPO POLYESTER REINFORCED</p>		 <p>DOUBLED 1400S162-97 STRUCTURAL STUD BLOCKING (BY OTHERS) BELOW</p> <p>2X2 14ga TUBING (T14)</p> <p>2'-4"</p> <p>INSTALL FASTENERS IN HOLES INDICATED Ø0.313 THRU (X4)</p> <p>SECTION A-A</p> <p>MAT'L: (TUBE) ASTM-A500 CRS, 14ga/ (PLATE) ASTM-A1018 GR36 HRS, ½" FINISH: (TUBE) GALVANIZED/ (PLATE) SHOP PRIME</p>		 <p>SQUARE POST CAP SLIP ON (C41)</p> <p>TEK SCREWS (S37)</p> <p>STORM COLLAR</p> <p>Ø½"-20 x ¾" LONG STAINLESS STEEL BOLT & NUT</p> <p>FLASHCLAMP</p> <p>SQUARE POST BASE FLASHING</p> <p>SQUARE POST BASE SUPPORT</p>		REV/	DESCRIPTION	BY	DATE			
4	SQUARE POST CAP CONN	SCALE: NTS	3	F31 TPO FLASHING FOR 2x2" SQUARE TUBE	SCALE: NTS	2	"SPS" 2'-7" SQUARE POST SUPPORT	SCALE: NTS	1	SQUARE POST SUPPORT ASSEMBLY EXPLODED	SCALE: NTS			
 <p>SLIDE TOP DIAG. SQUARE TUBING OVER BOTTOM DIAG. SQUARE TUBING. ADJUST POSITIONING TO LINE UP WITH VERT. TUBING PRIOR TO FASTENING AS SHOWN IN DTL 9/RS-4</p>		 <p>ATTACH BOTTOM DIAG. TUBE TO HORIZ. TUBE W/ Ø½" x 3" SS BOLT - P/N B38, Ø½" SS FLAT WASHER - P/N W18, Ø½" SS LOCKWASHER - P/N W24, AND SS NUT - P/N N12. DO NOT FULLY TIGHTEN UNTIL ALL FRAME ADJUSTMENTS HAVE BEEN MADE</p>		 <p>HORIZ. SQUARE TUBING (T14)</p> <p>VERT. SQUARE TUBING (T14.1)</p> <p>(4) #12-14 T/3 TEK SCREWS, P/N S10 EA SIDE OF HORIZONTAL TUBING END BRACKET (8 TOTAL)</p> <p>NOTE: INSTALLER MAY WANT TO PIN THE VERTICAL TUBE WITH ONLY ONE TEK SCREW PER SIDE AT THIS TIME TO ALLOW FOR ROTATION & FURTHER ADJUSTMENT DURING FRAME ASSEMBLY. REMAINING TEK SCREWS CAN BE INSTALLED ONCE FRAME ADJUSTMENTS ARE COMPLETE.</p>		 <p>HORIZ. SQUARE TUBING (T14)</p> <p>SQUARE POST CAP (C41)</p> <p>SQUARE POST SUPPORT (SPS)</p> <p>(4) #12-14 T/3 TEK SCREWS, P/N "S10" EA SIDE OF SQUARE POST CAP (8 TOTAL)</p>		REV/	DESCRIPTION	BY	DATE			
8	TOP DIAG. TUBE TO BOTTOM CONN	SCALE: NTS	7	BOTTOM DIAG. TUBE TO HORIZ. CONN	SCALE: NTS	6	HORIZ. SQUARE TUBE TO VERT. CONN	SCALE: NTS	5	SQUARE POST CAP CONN	SCALE: NTS			
 <p>C42.1 SQUARE TO FLAT CONNECTOR</p> <p>VERTICAL SQUARE TUBE</p> <p>(T14) BRACE TUBE, FIELD MEASURE AND CUT TO LENGTH</p> <p>DOWN SLOPE AS SHOWN ON RS-1</p> <p>C42.1 SQUARE TO FLAT CONNECTOR</p>		 <p>INSTALL FASTENERS IN (2) OF THE (3) HOLES INDICATED</p> <p>SECTION A-A</p> <p>VERTICAL SQUARE TUBING - P/N "T14.1"</p> <p>SQUARE TO FLAT CONNECTOR - ROOFSCREEN P/N "C42.1" FOR LATERAL BRACE</p> <p>CONN. LATERAL BRACE TUBE TO SQUARE TO FLAT CONNECTOR W/ #12-14 X 1" LONG T/3 SDS "TEK" SCREWS - P/N "S10", (2) EA. FLANGE, (4) TOTAL</p> <p>LATERAL BRACE TUBE - P/N "T14"</p> <p>5.845</p> <p>2.1</p> <p>1.8</p> <p>C42.1</p> <p>C42.2</p> <p>C42.1 & C42.2 SQUARE TO FLAT CONNECTOR</p>		 <p>VERTICAL OR HORIZONTAL SQUARE TUBING</p> <p>SQUARE TO FLAT CONNECTOR - ROOFSCREEN P/N "C42.1" OR "C42.2"</p> <p>CONN. SQUARE TO FLAT CONNECTOR TO SQUARE TUBING W/ #12-14 X 1" LONG T/3 SDS "TEK" SCREWS - P/N "S10", (2) MIN PER FLANGE, (4) TOTAL</p> <p>SECTION A-A</p> <p>5.845</p> <p>2.1</p> <p>1.8</p> <p>C42.1</p> <p>C42.2</p> <p>C42.1 & C42.2 SQUARE TO FLAT CONNECTOR</p>		 <p>ROTATE DIAG. SQUARE TUBING ASSEMBLY UNTIL BOLT HOLES ALIGN</p> <p>TOP DIAG. SQUARE TUBING (T14)</p> <p>BOTTOM DIAG. SQUARE TUBING (T14.1)</p> <p>PLUMB VERT TUBE & ADJUST TOP DIAG. SQUARE TUBING AS NEEDED PRIOR TO INSTALLING TEK SCREWS</p> <p>FASTEN W/ (3) #12-14 T/3 TEK SCREWS, P/N S10 EA SIDE (6 TOTAL)</p> <p>Ø½" x 3" SS BOLT - P/N B38, Ø½" SS FLAT WASHER - P/N W18, Ø½" SS LOCKWASHER - P/N W24, AND SS NUT - P/N N12 THRU TOP DIAG. SQUARE TUBING AND VERT. SQUARE TUBING</p> <p>VERT. SQUARE TUBING (T14.1)</p> <p>HORIZ. SQUARE TUBING (T14)</p>		REV/	DESCRIPTION	BY	DATE			
12	LATERAL BRACE ASSEMBLY	SCALE: NTS	11	LATERAL BRACE ATTACHMENT W/C42.1	SCALE: NTS	10	SQUARE TO FLAT CONNECTOR (C42.1 & C42.2)	SCALE: NTS	9	DIAG. TUBING ADJUSTMENT	SCALE: NTS			
 <p>SQUARE TO FLAT CONNECTOR - ROOFSCREEN P/N "C42.2" FOR LATERAL BRACE</p> <p>HORIZONTAL SQUARE TUBING - P/N "T14"</p> <p>"BD" BOTTOM DIAGONAL TUBE - P/N "T14.1"</p> <p>INSTALL FASTENER IN HOLE INDICATED</p> <p>CONN. DIAGONAL TUBE TO SQUARE TO FLAT CONNECTOR W/ Ø½" x 3" SS BOLT - P/N B38, Ø½" SS FLAT WASHER - P/N W18, Ø½" SS LOCKWASHER - P/N W24, AND SS NUT - P/N N12 (1) TOTAL</p> <p>SIDE VIEW</p>		 <p>2" (2X)</p> <p>(2X) ½"</p> <p>FINISH SIDE</p> <p>TR45 TRIM CAP</p> <p>PLEASE NOTE PANEL FLANGE ORIENTATION</p> <p>FRONT</p> <p>PANEL</p> <p>TR45 TRIM CAP</p> <p>S16 SELF DRILLING SCREW THROUGH FACE OF TRIM CAP INTO PANEL @ 3'-0" O.C.</p> <p>S16: COLORED PANEL SCREW, #12X1", SELF DRILLING W/ NEOPRENE WASHER</p>		 <p>5" (2X)</p> <p>FINISH SIDE</p> <p>½" (2X) OPEN PARALLEL HEM (TYP)</p> <p>MATERIALS AND FINISH TO MATCH PANELS</p> <p>3" (2X)</p> <p>16ga</p> <p>OUTSIDE CORNER APPLICATION: (HORIZONTAL PANELS)</p> <p>CORNER TRIM PANEL FINISH SIDE</p> <p>TR37, ATTACH TO PANELS W/#12-14 X1" T/3 TEK SCREWS, P/N S10, FROM FINISH SIDE, COVER WITH TRIM</p>		 <p>3'-0" Coverage</p> <p>1½"</p> <p>7¼"</p> <p>2½"</p> <p>FASTEN W/COLOR MATCHED PANEL SCREWS, #12 X 1" LONG SELF DRILLING TEK SCREW W/NEOPRENE WASHER - ROOFSCREEN P/N S16</p> <p>MAT'L: 24ga STEEL FINISH: KYNAR 500 (PVDF) NET WEIGHT: 3.69 plf</p>		REV/	DESCRIPTION	BY	DATE			
17	DIAGONAL TO HORIZONTAL ATTACH (C42.2)	SCALE: NTS	16	TRIM END & CAP (TR45), 7.2 RIB (P10) ATTACHMENT	SCALE: NTS	15	OUTSIDE CORNER 5" X 5" (TR21)	SCALE: NTS	14	TR37 STIFFENER, HORIZONTAL PANELS	SCALE: NTS	13	P10 7.2 RIB PANEL	SCALE: NTS

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RS-4

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RS-4